

AVERAGE NATURAL/FINISHED GRADE CALCULATIONS

								TOTAL (CT)
	ELEV (FT)		ELEV (FT)	_			LENGTH (FT)	TOTAL (FT)
A-B	130.40	+	132.30	/2 =	131.35	X	25.20	3310.02
B-C	132.30	+	132.10	/2 =	132.20	X	16.00	2115.20
C- C1	132.10	+	132.20	/2 =	132.15	X	2.00	264.3
C1-C2	132.20	+	132.80	/2 =	132.50	X	8.5	1126.25
C2-C3	132.80	+	132.80	/2 =	132.80	X	3.2	424.96
C3-C4	132.80	+	132.80	/2 =	132.80	X	2.6	345.28
C4-C5	132.80	+	132.80	/2 =	132.80	X	2.8	371.84
C5-C6	132.80	+	133.10	/2 =	132.95	X	15.7	2087.32
C6-C7	133.10	+	132.80	/2 =	132.95	X	13.3	1768.24
C7-C8	132.80	+	132.80	/2 =	132.80	X	4.3	571.04
C8-D	132.80	+	132.70	/2 =	132.75	X	3.2	424.80
D-E	132.70	+	132.40	/2 =	132.55	X	12.60	1670.13
E-F	132.40	+	132.30	/2 =	132.35	X	2.00	264.70
F-G	132.30	+	130.90	/2 =	131.60	X	19.90	2618.84
G-H	130.90	+	123.70	/2 =	127.30	X	15.40	1960.42
H-I	123.70	+	123.70	/2 =	123.70	X	13.50	1669.95
I-J	123.70	+	123.70	/2 =	123.70	X	12.50	1546.25
J-K	123.70	+	123.70	/2 =	123.70	X	21.50	2659.55
K-L	123.70	+	123.50	/2 =	123.60	X	20.80	2570.88
L-M	123.50	+	127.90	/2 =	125.70	X	23.60	2966.52
M-N	127.90	+	129.50	/2 =	128.70	X	3.60	463.32
N-A	129.50	+	130.40	/2 =	129.95	X	16.80	2183.16
	SUBTOTALS 259						33,382.97	
	AVERAGE NATURAL/ FINISHED GRADE: 128.9							

OF SERVICE AND MUST ONLY BE USED IN CORRESPONDENCE AND INFORMATION PERTINENT TO THE PROJECT.

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THE CONTRACTOR SHALL VERIFY ON SITE AND REQUEST CLARIFICATION FROM THE DESIGN TEAM OF ANY

COMPLIANCE OF ALL WORK WITH THE REQUIREMENTS OF ALL AUTHORITIES HAVING JURISDICTION.

DO NOT SCALE DRAWINGS ABBREVIATIONS:

U.N.O.- UNLESS NOTED OTHERWISE

I/S- INSIDE o.c.- ON CENTER TYP- TYPICAL

D.F. - DOUGLAS FIR GWB- GYPSUM WALL BOARD (DRYWALL) PT- PRESSURE TREATED

CONT- CONTINUOUS **ELEV- ELEVATION** O/H- OVERHANG

ENG- ENGINEERED T & G- TONGUE AND GROOVE EXT.- EXTERIOR

THESE DRAWINGS COMPLY TO THE **BCBC 2018 INCLUDING ALL REVISIONS** AND AMENDMENTS. ALL WORK IS TO ALSO COMPLY WITH THE BCBC 2018 INCLUDING ALL REVISIONS AND

FLOOR AREA

AMENDMENTS.

EXIST UPPER FLR: 1684 SQ FT UPPER FLR ADD: 99.7 SQ FT EXIST LWR FLR: 1320 SQ FT LWR FLR ADD: 201 SQ FT TQTAL AREA: 3304.7 SQ FT

ADJUSTED THE SQUARE FOOTAGE INFORMATION TO INCLUDE THE NEW **ADDITION TO**

THE FOOTPRINT

6 JULY 23, 2022 REVISIONS 5 JUNE 18, 2022 FEB 18, 2022 OCT 25, 2021 AUG 18, 2021 JUNE 15, 2021 ISSUED FOR BF

DATE

ADDITION/RENOVATION BROOKS RESIDENCE 1421 31ST STREET WEST VANCOUVER, B.C.


AVERAGE GRADE CACULATIONS

SHEET TITLE:

DRAWN BY: LULUA L. CHECKED BY:

DATE: 9/28/2022 SCALE: AS NOTED

A-0.1

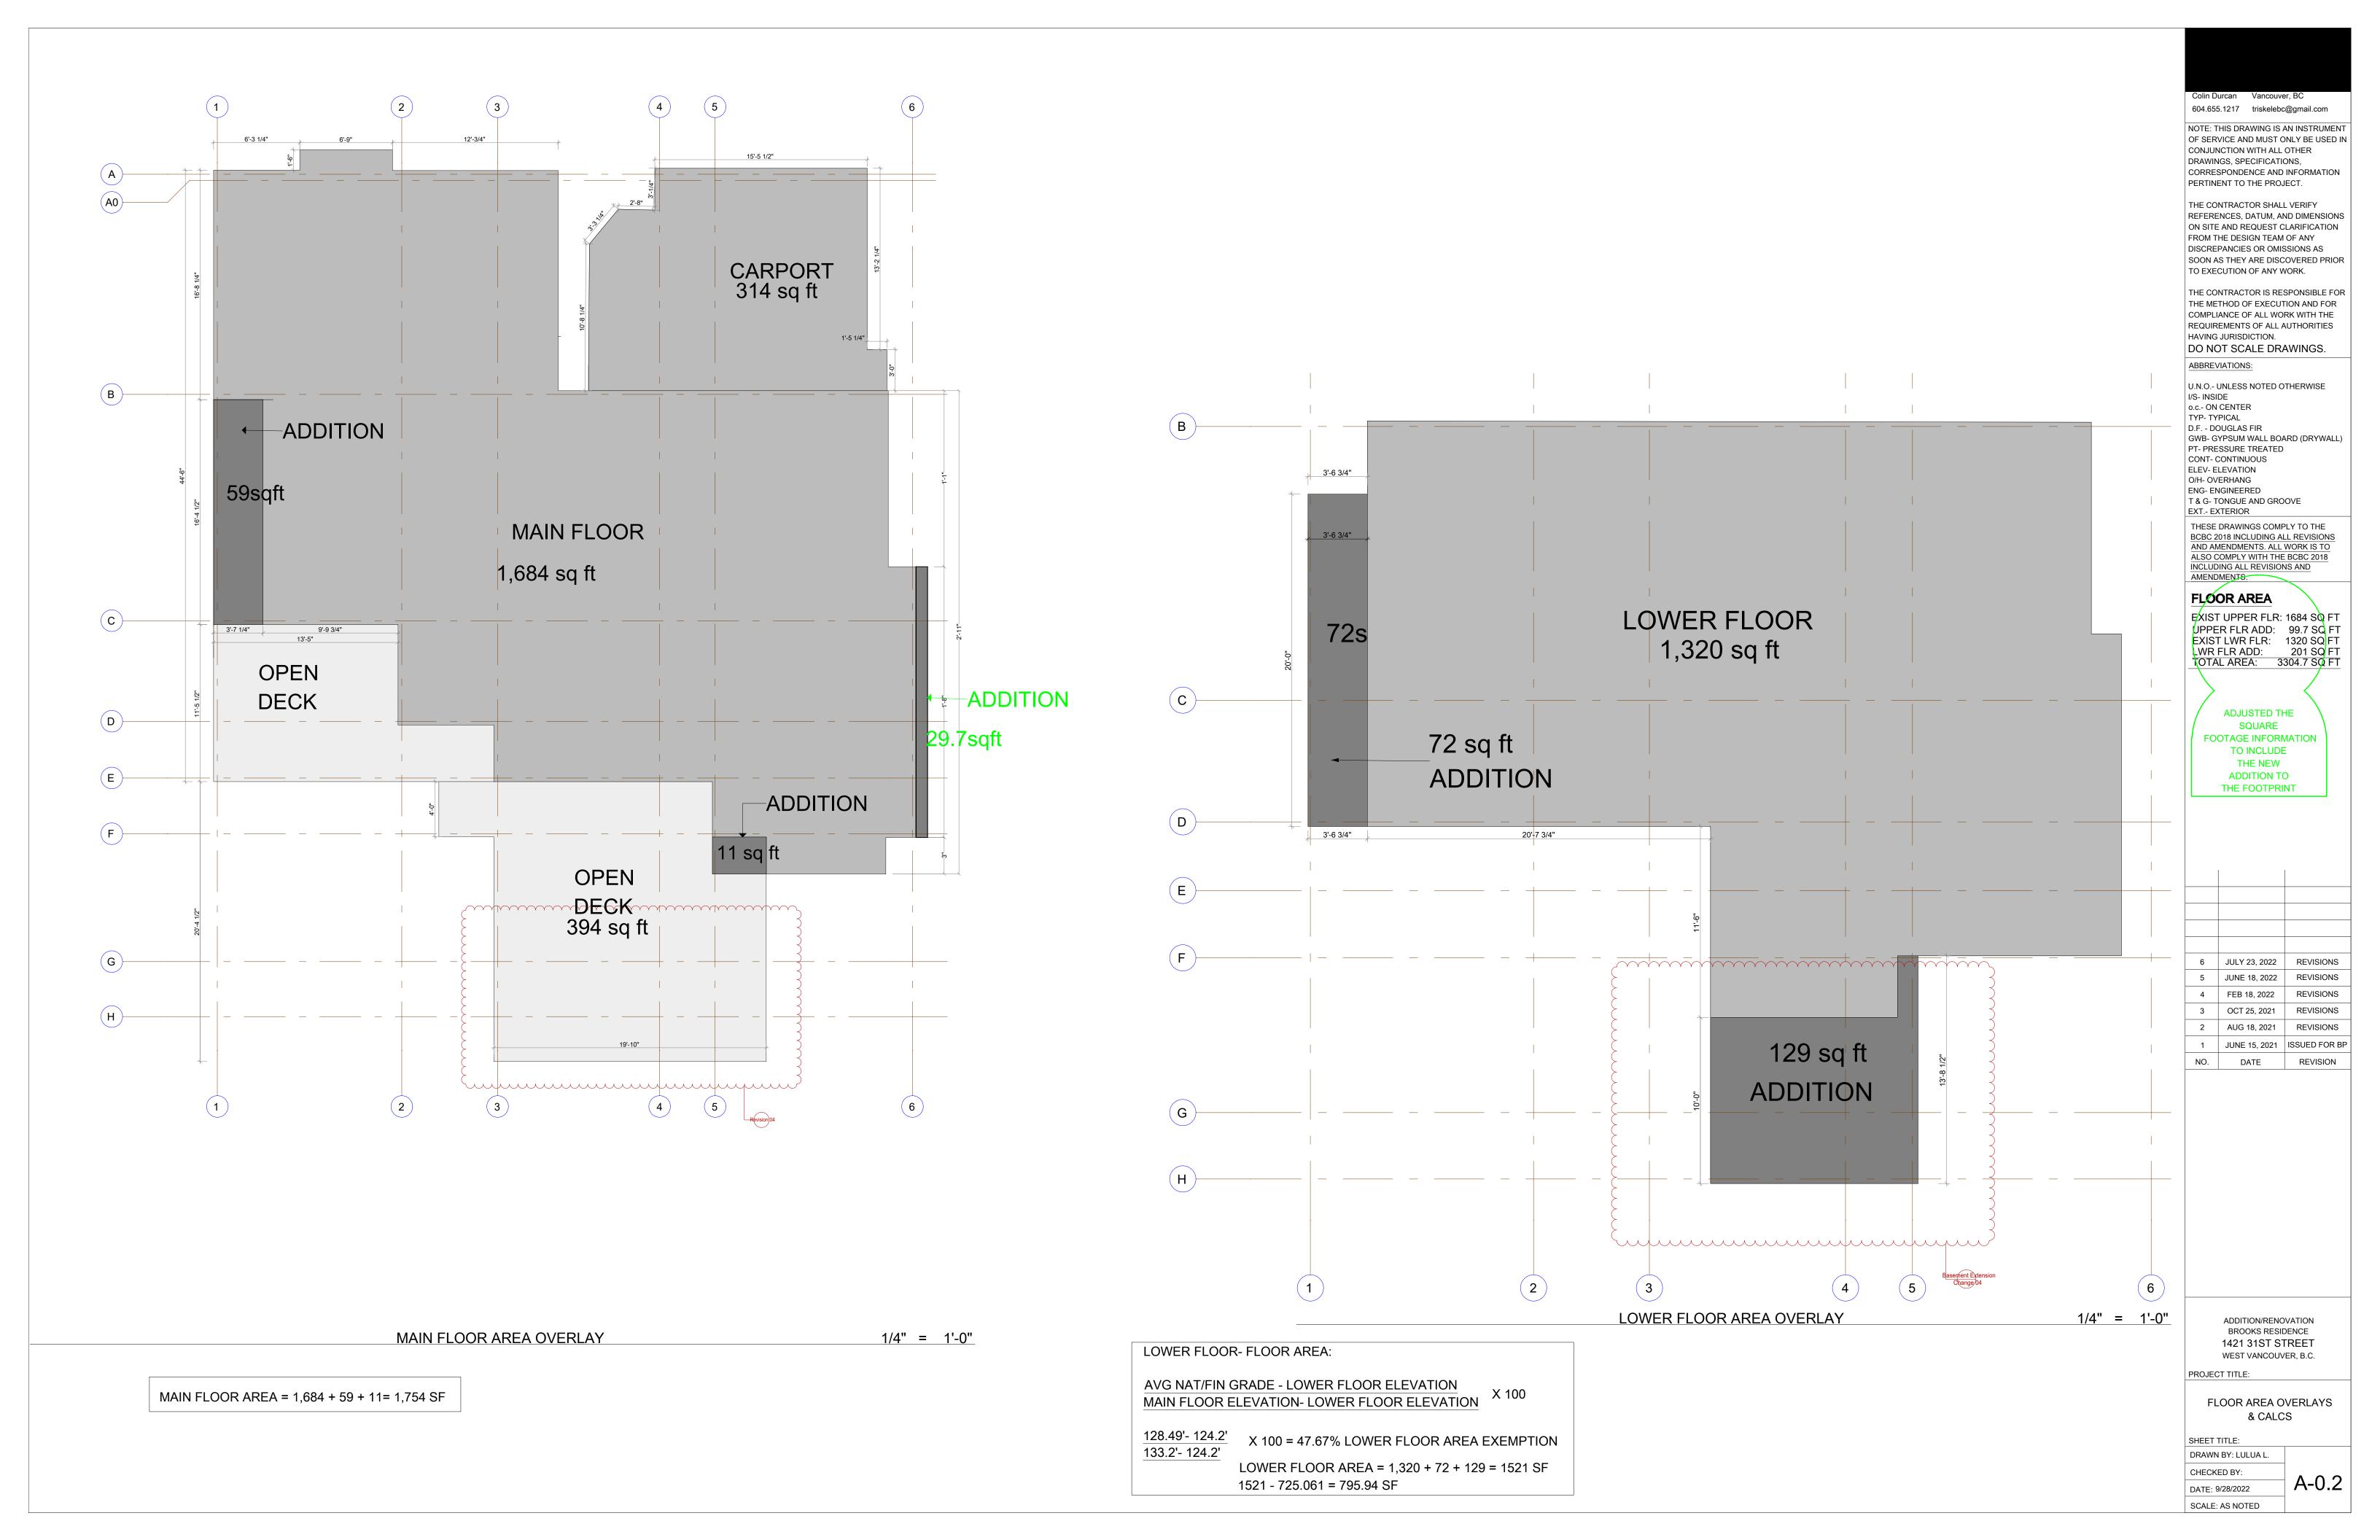

GENERAL CONSTRUCTION NOTES:

ALL CONSTRUCTION TO BE IN ACCORDANCE WITH MUNICIPAL BY-LAWS, B.C. BUILDING CODE 2018, WORKSAFE BC REGULATIONS, AND AUTHORITIES HAVING JURISDICTION. ERRORS OR OMISSIONS IN THE PLANS OR SPECIFICATIONS WILL NOT REMOVE THE OBLIGATION FOR THE CONTRACTOR OR SUBCONTRACTOR TO ENSURE ALL CONSTRUCTION COMPLIES WITH ALL APPLICABLE CODES AND REGULATIONS

ALL WORK TO BE COMPLETED TO CURRENT STANDARDS BY SKILLED TRADES.

ALL MATERIALS TO BE OF GOOD QUALITY, AND PROPERLY TRANSPORTED, STORED AND PROTECTED.

BEARING SOIL TO BE INSPECTED BY PROPER AUTHORITIES BEFORE COMMENCEMENT OF FORMWORK.

PROVIDE MINIMUM 8" CLEARANCE BETWEEN ANY WOOD MEMBERS AND SOIL.

THE CONTRACTOR SHALL CHECK AND VERIFY ALL DIMENSIONS, ELEVATIONS, INFORMATION, SPECIFICATIONS, SITE CONDITIONS ETC., PRIOR TO STARTING CONSTRUCTION. ANY DISCREPANCIES, ERRORS, OR OMISSIONS NOT REPORTED TO THE DESIGN TEAM, ETC., BECOME THE RESPONSIBILITY OF THE CONTRACTOR.

WRITTEN SPECIFICATIONS OR AMENDMENTS BY AUTHORITIES HAVING JURISDICTION SHALL OVERRIDE ANY SPECIFICATIONS OR NOTATIONS ON DRAWINGS. CONTRACTORS, SUPPLIERS, SUBTRADES, ETC., ARE TO ENSURE THEY ARE WORKING WITH CURRENT DRAWINGS AND SHOULD VERIFY THAT THEY ARE IN POSSESSION OF LATEST ISSUE. OBSOLETE DRAWINGS TO BE RECYCLED.

ANY VARIANCES FROM THESE DRAWINGS AND SPECIFICATIONS OR FROM CONDITIONS ENCOUNTERED AT THE JOB SITE SHALL BE RESOLVED BY THE CONTRACTOR AND SUCH SOLUTIONS SHALL BE THEIR SOLE RESPONSIBILITY.

THE CONTRACTOR SHALL SUPERVISE THE WORK OF SUBCONTRACTORS AND BE RESPONSIBLE TO THE OWNER FOR SUCH WORK AS IF IT WERE CARRIED OUT BY THEM-SELF. THE CONTRACTOR SHALL ENSURE THAT ALL SUBCONTRACTORS RECEIVE A COPY OF RELEVANT WRITTEN SPECIFICATIONS AND DRAWINGS.

ALL FIGURED DIMENSIONS TO TAKE PRECEDENCE OVER SCALE SHOWN ON PLANS, SECTIONS, AND DETAILS. WHERE NOTES AND DETAILS ON DRAWINGS EXCEED MINIMUMS OF GENERAL NOTES AND TYPICAL DETAILS, THEY SHALL TAKE PRECEDENCE.

CIVIL, ELECTRICAL, MECHANICAL, SOILS, GEOTECHNICAL, STRUCTURAL ENGINEERING, ETC., MAY BE REQUIRED BY THE AUTHORITIES HAVING JURISDICTION. IT IS THE DEVELOPER OR CONTRACTOR'S RESPONSIBILITY TO PROVIDE AND PAY FOR THESE SERVICES

THE CONTRACTOR SHALL BE RESPONSIBLE FOR THE CORRECT SITING OF THE NEW RESIDENCE ON THE PROPERTY AND FOR CONFIRMATION OF ALL REQUIREMENTS FOR SITING.

THE CONTRACTOR IS RESPONSIBLE FOR ALL TEMPORARY BRACING REQUIRED FOR CONSTRUCTION LOADS AND STABILITY UNTIL THE PROJECT IS COMPLETED. CONSTRUCTION LOADS ON THE STRUCTURE CAUSED BY INTERIM STORAGE OF MATERIALS OR USE OF MATERIALS SHALL NOT BE ALLOWED TO EXCEED THE DESIGN LOADS.

THE CONTRACTOR IS RESPONSIBLE FOR SAFETY ON THE JOB SITE AND CONFORMANCE TO WORKSAFE BC REGULATIONS THROUGHOUT CONSTRUCTION.

WELLS AND SEPTIC DISPOSAL SYSTEMS ARE TO BE LOCATED AND CONSTRUCTED IN ACCORDANCE WITH REGULATIONS DURING CONSTRUCTION.

THE CONTRACTOR IS RESPONSIBLE TO ENSURE THAT WATER COLLECTED IN THE GUTTERS, DOWNSPOUTS AND FOUNDATION PERIMETER DRAINS IS DISCHARGED IN ACCORDANCE WITH REQUIREMENTS OF LOCAL AUTHORITIES HAVING JURISDICTION.

CONCRETE FOOTINGS ARE TO PLACED ON COMPACT FILL, OR SOLID UNDISTURBED BEARING AND BELOW FROST LINE.

GRADES SHOWN ON ELEVATIONS ARE ESTIMATED. ADJUST ON SITE AS REQUIRED. RETAINING WALLS OTHER THAN THE FOUNDATION WALLS OF THE RESIDENCE, ARE BEYOND THE SCOPE OF THESE DRAWINGS UNLESS NOTED OTHERWISE.

ALL CONCRETE FOUNDATION WALLS ARE TO HAVE MINIMUM 1-15 M CONTINUOUS BAR AT TOP. ALL CONCRETE FOOTINGS ARE TO HAVE MINIMUM 2-15 M CONTINUOUS BARS. CONCRETE REINFORCING SHALL BE SUPPORTED BY APPROVED SUPPORTS, SPACERS OR HANGERS PER BCBC 2018.

FOUNDATION WALLS SHALL NOT BE BACK FILLED UNTIL CONCRETE HAS REACHED IT'S SPECIFIED 28 DAY STRENGTH, OR UNTIL ADEQUATELY BRACED SUBJECT TO APPROVAL BY AUTHORITIES HAVING JURISDICTION.

ALL FRAMING, BRIDGING, BLOCKING, NAILING, ETC., SHALL CONFORM TO B.C. BUILDING CODE, 2018, SECTION 9.23.

WOOD PLATES ARE TO BE ANCHORED TO FOUNDATION WALL WITH 1/2 INCH DIAM. ANCHOR BOLTS AT MAXIMUM 6 FEET O/C. WOOD PLATES ARE TO BE SEPARATED FROM CONCRETE WITH FOAM SILL GASKET.

UNLESS NOTED OTHERWISE, LUMBER SHALL BE 1/2" PLYWOOD (WITH H CLIPS) FOR ROOF SHEATHING, 5/8 INCH T&G PLYWOOD (GLUED AND SCREWED) FOR FLOOR SHEATHING, 1/2" PLYWOOD FOR WALL SHEATHING, K.D. SPF NO.2 AND BETTER FOR BUILT-UP BEAMS, K.D. SPF NO.2 AND BETTER FOR FLOOR JOISTS AND ROOF FRAMING, D.FIR NO.1 FOR POSTS, AND K.D. SPF NO.2 AND BETTER FOR WALL STUDS. (ALL EXTERIOR PORCH AND DECK FRAMING TO BE TREATED LUMBER.)

USE MGA OR SIMPSON STRONGTIE CONNECTOR HARDWARE WHERE REQUIRED.

ALL LINTELS OVER WINDOW AND DOOR OPENINGS TO BE 2-2 X 10 UNLESS NOTED OTHERWISE. SPANS OVER 6 FEET TO HAVE 2 CRIPPLES AND 3-2 X 10 LINTEL.

PROVIDE SOLID BLOCKING BETWEEN JOISTS AT ALL LOAD BEARING WALLS, TOP OF BEAMS OR HEADERS, BUILT-UP POSTS AND AT

PROVIDE CONTINUOUS CROSS BRIDGING BETWEEN FLOOR JOISTS AT MAX. 6'-10" APART ALONG THE SPAN OF THE JOIST. MINIMUM

PROVIDE DOUBLE JOISTS UNDER ALL PARTITION WALLS PARALLEL TO JOIST SPAN.

ALL SUPPORTS FOR CANTILEVERED JOISTS

CONTINUE ALL POSTS AND CRIPPLES DOWN TO FOUNDATION COMPLETE WITH BLOCKING IN JOIST SPACE.

MANUFACTURED WOOD TRUSSES, JOISTS, AND/OR BEAMS ARE TO BE ENGINEERED BY THE MANUFACTURER AND INSTALLED AND BRACED PER THE MANUFACTURER'S INSTRUCTIONS. LAYOUT SHOWN ON PLANS TO BE CONFIRMED WITH MANUFACTURER PRIOR

CONTRACTOR IS TO OBTAIN AN ENGINEER'S CERTIFICATE FROM THE MANUFACTURER OF ROOF TRUSSES, JOISTS, AND/OR BEAMS. PROVIDE A MINIMUM OF 4 SETS OF ENGINEERED SEALED SHOP DRAWINGS WITH NAME OF PROJECT ON DRAWINGS AND DATE

IT IS THE CONTRACTOR'S RESPONSIBILITY TO ENSURE ALL INSTALLATION OF ELECTRICAL ITEMS COMPLY WITH LOCAL ELECTRICAL CODES AND REGULATIONS AND WITH LOCAL ELECTRICAL POWER SUPPLY REQUIREMENTS IN ALL RESPECTS.

APPROVED INTERCONNECTED SMOKE & C02 DETECTORS TO BE INSTALLED AS REQUIRED BY LOCAL AUTHORITIES HAVING

SAFETY GLASS- ALL GLAZING WITHIN 36" OF DOOR LOCKS TO BE SAFETY GLASS. ALL GLAZING WITHIN 8" OF FLOOR TO BE SAFETY GLASS. ALL GLAZING OVER 20" (THAT COULD BE MISTAKEN FOR DOORS) TO BE SAFETY GLASS. ALL GLAZING IN EXTERIOR DOORS TO BE SAFETY GLASS. ALL GLAZING IN WALLS ENCLOSING BATHTUBS OR SHOWERS TO BE SAFETY GLASS AND WATERPROOFED TO THE SATISFACTION OF AUTHORITIES HAVING JURISDICTION.

SUPPLY AND INSTALL EXHAUST FANS AND DUCTING IN ALL BATHROOMS AND KITCHENS AS REQ'D.

WATERPROOF MEMBRANE TO BE INSTALLED AND FITTED TIGHTLY TO WALLS AND FLOOR OF ALL TILED SHOWERS, AND NOT TO BE PENETRATED BY FASTENERS OF ANY KIND.

INSTALLATION OF ENTIRE HEATING SYSTEM, WHETHER ELECTRIC, FORCED WARM AIR, HOT WATER, SOLID FUEL, ETC., SHALL COMPLY WITH MANUFACTURER'S DIRECTIONS WHERE APPLICABLE AND CONFORM WITH LOCAL CODES AND REGULATIONS IN ALL RESPECTS. CONTRACTOR TO OBTAIN ALL REQUIRED PERMITS.

FUEL BURNING APPLIANCES, INCLUDING FURNACES, FIRE PLACES, WOOD STOVES, ETC., ARE TO BE INSTALLED PER THE MANUFACTURER'S INSTRUCTIONS AND IN ACCORDANCE WITH CURRENT NATIONAL, PROVINCIAL, AND LOCAL BUILDING CODES.

6 MIL POLY VAPOUR BARRIER SHALL BE INSTALLED ON THE WARM SIDE OF INSULATION. INSULATION REQUIREMENTS MAY VARY WITH HEATING SYSTEMS AND LOCAL CONDITIONS. IT IS THE CONTRACTOR'S RESPONSIBILITY TO ENSURE THE INSULATION VALUES COMPLY WITH WITH LOCAL REQUIREMENTS.

ALL ROOF SPACES SHALL BE VENTILATED WITH SOFFIT, ROOF, OR GABLE VENTS, OR A COMBINATION OF THESE EQUALLY DISTRIBUTED BETWEEN TOP OF ROOF SPACE AND SOFFITS.

ATTICS OR ROOF SPACES TO BE VENTED MINIMUM 1/300 OF AREA. UNHEATED CRAWLSPACES TO BE VENTED MINIMUM 1/500 OF AREA WITH CLOSE-ABLE VENTS.

ALL MASONRY APPLICATIONS SHALL BE IN ACCORDANCE WITH ALL APPLICABLE CODES.

ALL FIREPLACE AND CHIMNEY INSTALLATIONS SHALL BE GOVERNED, INSPECTED AND APPROVED BY MUNICIPAL AUTHORITIES. CONTRACTOR TO OBTAIN ALL REQUIRED PERMITS.

ZERO CLEARANCE TYPE METAL FIREPLACES AND METAL CHIMNEYS TO BE CSA APPROVED AND INSTALLED PER THE

COVERING CODE: B.C. BUILDING CODE 2018, INCLUDING ALL AMENDMENTS

CONSTRUCTION ASSEMBLY SCHEDULE

2 X 6" EXTERIOR WALL WOOD SIDING ON 3/8" RAINSCREEN SYSTEM ON HOUSE WRAP ON 1/2" PLYWOOD SHEATHING ON 2 X 6" STUDS (SEE STRUCTURAL FOR DETAILS) W/ R-24 BATT INSULATION 6 MIL POLY VAPOUR BARRIER

1/2" INTERIOR WALL GYPSUM BOARD (PAINTED) 2 X 4" INTERIOR PARTITION 2 X 4 STUDS (SEE STRUCTURAL FOR DETAILS) 1/2" WALL GYPSUM BOARD TO BOTH SIDES (PAINTED)

6'-2 3/4"

3'-5 1/2"

D

2 X 6" INTERIOR PARTITION 2 X 6 STUDS (SEE STRUCTURAL FOR DETAILS) 1/2" WALL GYPSUM BOARD TO BOTH SIDES (PAINTED)

12'-1 1/4"

EXISTING

FOUNDATION

(SEE STRUCTURAL FOR DETAILS) FLOOR ASSEMBLY B FINISHED FLOOR ON 4" CONC SLAB ON 3" RIGID XPS INSUL. ON 6 MIL POLY V.B. ON 6" GRANULAR FILL ON COMPACT FILL TYP EXTERIOR FOUNDATION WALL

3/4" T&G WOOD SOFFITS (PAINTED/STAINED)

FINISHED FLOOR ON

ENGINEERED FLOOR JOISTS W/

R-31 SPRAY FOAM INSULATION

DAMPPROOFING AS REQ'D

DELTA DRAIN MAT ON 8" CONCRETE FOUNDATION WALL W/

FLOOR ASSEMBLY A (COLD FLOOR)

5/8" T&G PLYWOOD SUBFLOOR (GLUED & SCREWED) ON

(SEE STRUCTURAL FOR DETAILS)

OLD FDTN WALL

(UNUSED)

NEW FULL HEIGHT

CONCRETE WALL

(SEE STRUCTURAL)

WATERPROOF DECK/FLAT ROOF WATERPROOF DECKING MEMBRANE

(MEMBRANE TO WRAP 8" UP EXTERIOR WALLS BEHIND SIDING) ON 1/2" T&G PT PLYWOOD SHEATHING ON PT SLEEPERS (@ 1/4" PER FOOT SLOPE AWAY FROM DWELLING) ON DECK JOISTS (SEE STRUCTURAL) W/ R-31 SPRAY FOAM INSULATION 1/2" CD BOARD (PAINTED)

EXTERIOR DECK STAIR TOTAL RISE = 9'-8"

16 RISERS 10" RUNS PLUS 1" NOSING MINIMUM 6'-6" HEADROOM 36" HIGH CONTINUOUS GRASPABLE HANDRAIL PRESSURE TREATED WOOD W/ APPROPRIATE FASTENERS

1/4" = 1'-0"

DRAINAGE

ALL SITE DRAINAGE (FOUNDATION, STORM, ETC.) TO BE 4" PERF. PIPE 3" BELOW T/O SLAB (HOLES DOWN) W/ FILTER FABRIC (TO CONNECT TO EXIST PERIMETER/STORM DRAINAGE) ON MIN 6" COMPACT GRANULAR FILL ON (ON, AROUND AND BELOW PIPE) ON

COMPACT FILL EXIST/PROP ROOF

2 PLY WATERPROOF TORCH DOWN ROOF MEMBRANE (@ 1/4" PER FOOT SLOPE TO DRAINS) ON 1/2" FIBRE BOARD SHEATHING ON TAR & GRAVEL ROOF SYSTEM 2 LAYERS 1/2" FIBRE BOARD SHEATHING ON T&G TRUCK DECKING ON

DISCREPANCIES OR OMISSIONS AS SOON AS THEY ARE DISCOVERED PRIOR STRUCTURAL BEAMS (SEE STRUCT) TO EXECUTION OF ANY WORK. THE CONTRACTOR IS RESPONSIBLE FOR THE METHOD OF EXECUTION AND FOR

COMPLIANCE OF ALL WORK WITH THE REQUIREMENTS OF ALL AUTHORITIES HAVING JURISDICTION.

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NOTE: THIS DRAWING IS AN INSTRUMENT

OF SERVICE AND MUST ONLY BE USED IN

CORRESPONDENCE AND INFORMATION

REFERENCES, DATUM, AND DIMENSIONS

ON SITE AND REQUEST CLARIFICATION

CONJUNCTION WITH ALL OTHER

DRAWINGS, SPECIFICATIONS,

PERTINENT TO THE PROJECT.

THE CONTRACTOR SHALL VERIFY

FROM THE DESIGN TEAM OF ANY

DO NOT SCALE DRAWINGS.

ABBREVIATIONS: U.N.O.- UNLESS NOTED OTHERWISE I/S- INSIDE

o.c.- ON CENTER TYP- TYPICAL D.F. - DOUGLAS FIR

GWB- GYPSUM WALL BOARD (DRYWALL) PT- PRESSURE TREATED CONT- CONTINUOUS

O/H- OVERHANG **ENG- ENGINEERED**

> THESE DRAWINGS COMPLY TO THE ALSO COMPLY WITH THE BCBC 2018

FLOOR AREA

EXIST UPPER FLR: 1684 SQ F UPPER FLR ADD: 99.7 SQ FT EXIST LWR FLR: 1320 SQ FT LWR FLR ADD: 201 SQ FT

ADJUSTED THE

ALL POINT LOADS ARE TO BE INSTALLED RIGHT AWAY

ALL SONO TUBES ARE TO BE ACCURATELY LOCATED AND BRACED. POSTS MUST HAVE FULL BEARING ON CONCRETE COLUMNS

DIMENSION NOTES:

ALL EXTERIOR DIMENSIONS TAKEN TO EXT. FACE OF SHEATHING.

ALL FOUNDATION DIMENSIONS ARE TAKEN TO FACE OF ICF WALL OR EXTERIOR FACE OF CONCRETE FOR STANDARD CONC WALLS.

ALL INTERIOR DIMENSIONS ARE TAKEN TO FACE OF FRAMING.

WINDOW AND DOOR DIMENSIONS READ LENGTH BY HEIGHT (EG- 6040 MEANS 6'-0" WIDE BY 4'-0" HIGH).

* * * * * * * * *

CONTRACTOR TO CONFIRM ALL WINDOW AND DOOR ROUGH OPENINGS IN ADVANCE OF FRAMING. OPENINGS TO BE PER THE WINDOW OR DOOR MANUFACTURER'S SPECIFICATIONS.

SEE STRUCTURAL DRAWINGS FOR ALL TRUSS, JOIST, BEAM & POST LOCATIONS & SPECS, AS WELL AS CONCRETE SLAB & FDTN DETAILS.

ALL FRAMING IS TO BE DONE PER THE STRUCTURAL DRAWINGS. ANY "EQUIVALENT METHODS" MUST BE APPROVED IN WRITING BY THE ENGINEER PRIOR TO INSTALLATION.

ALL BLOCKING TO BE INSTALLED IN FLOOR SYSTEM AT FULL DIMENSION, GLUED & SCREWED ALONG WITH THE REST OF THE FLOOR. BLOCKING SHALL BE INSTALLED ON EITHER SIDE OF A SNAPPED CHALK LINE AND IS TO BE STRAIGHT AND PLUMB.

ELEV- ELEVATION

T & G- TONGUE AND GROOVE EXT.- EXTERIOR

BCBC 2018 INCLUDING ALL REVISIONS AND AMENDMENTS. ALL WORK IS TO INCLUDING ALL REVISIONS AND AMENDMENTS.

TOTAL AREA: 3304.7 SQ/FT

SQUARE FOOTAGE INFORMATION TO INCLUDE THE NEW **ADDITION TO** THE FOOTPRINT

6 JULY 23, 2022 REVISIONS 5 JUNE 18, 2022 REVISIONS FEB 18, 2022 REVISIONS OCT 25, 2021 REVISIONS AUG 18, 2021 REVISIONS JUNE 15, 2021 ISSUED FOR BP DATE

> ADDITION/RENOVATION BROOKS RESIDENCE 1421 31ST STREET WEST VANCOUVER, B.C.

PROJECT TITLE:

EXISTING & PROPOSED FOUNDATION PLAN

A-1.1

SHEET TITLE: DRAWN BY: LULUA L. CHECKED BY:

DATF: 9/28/2022 SCALE: AS NOTED

MANUFACTURER'S SPECIFICATIONS.

' - - - - - - - - - - - |- - - - - - - |- | 24'-2 3/4" 129 sq ft


SEE STRÚCTURAL


EXISTING/PROPOSED FOUNDATION PLAN


12'-5 3/4"

EXISTING

FOUNDATION

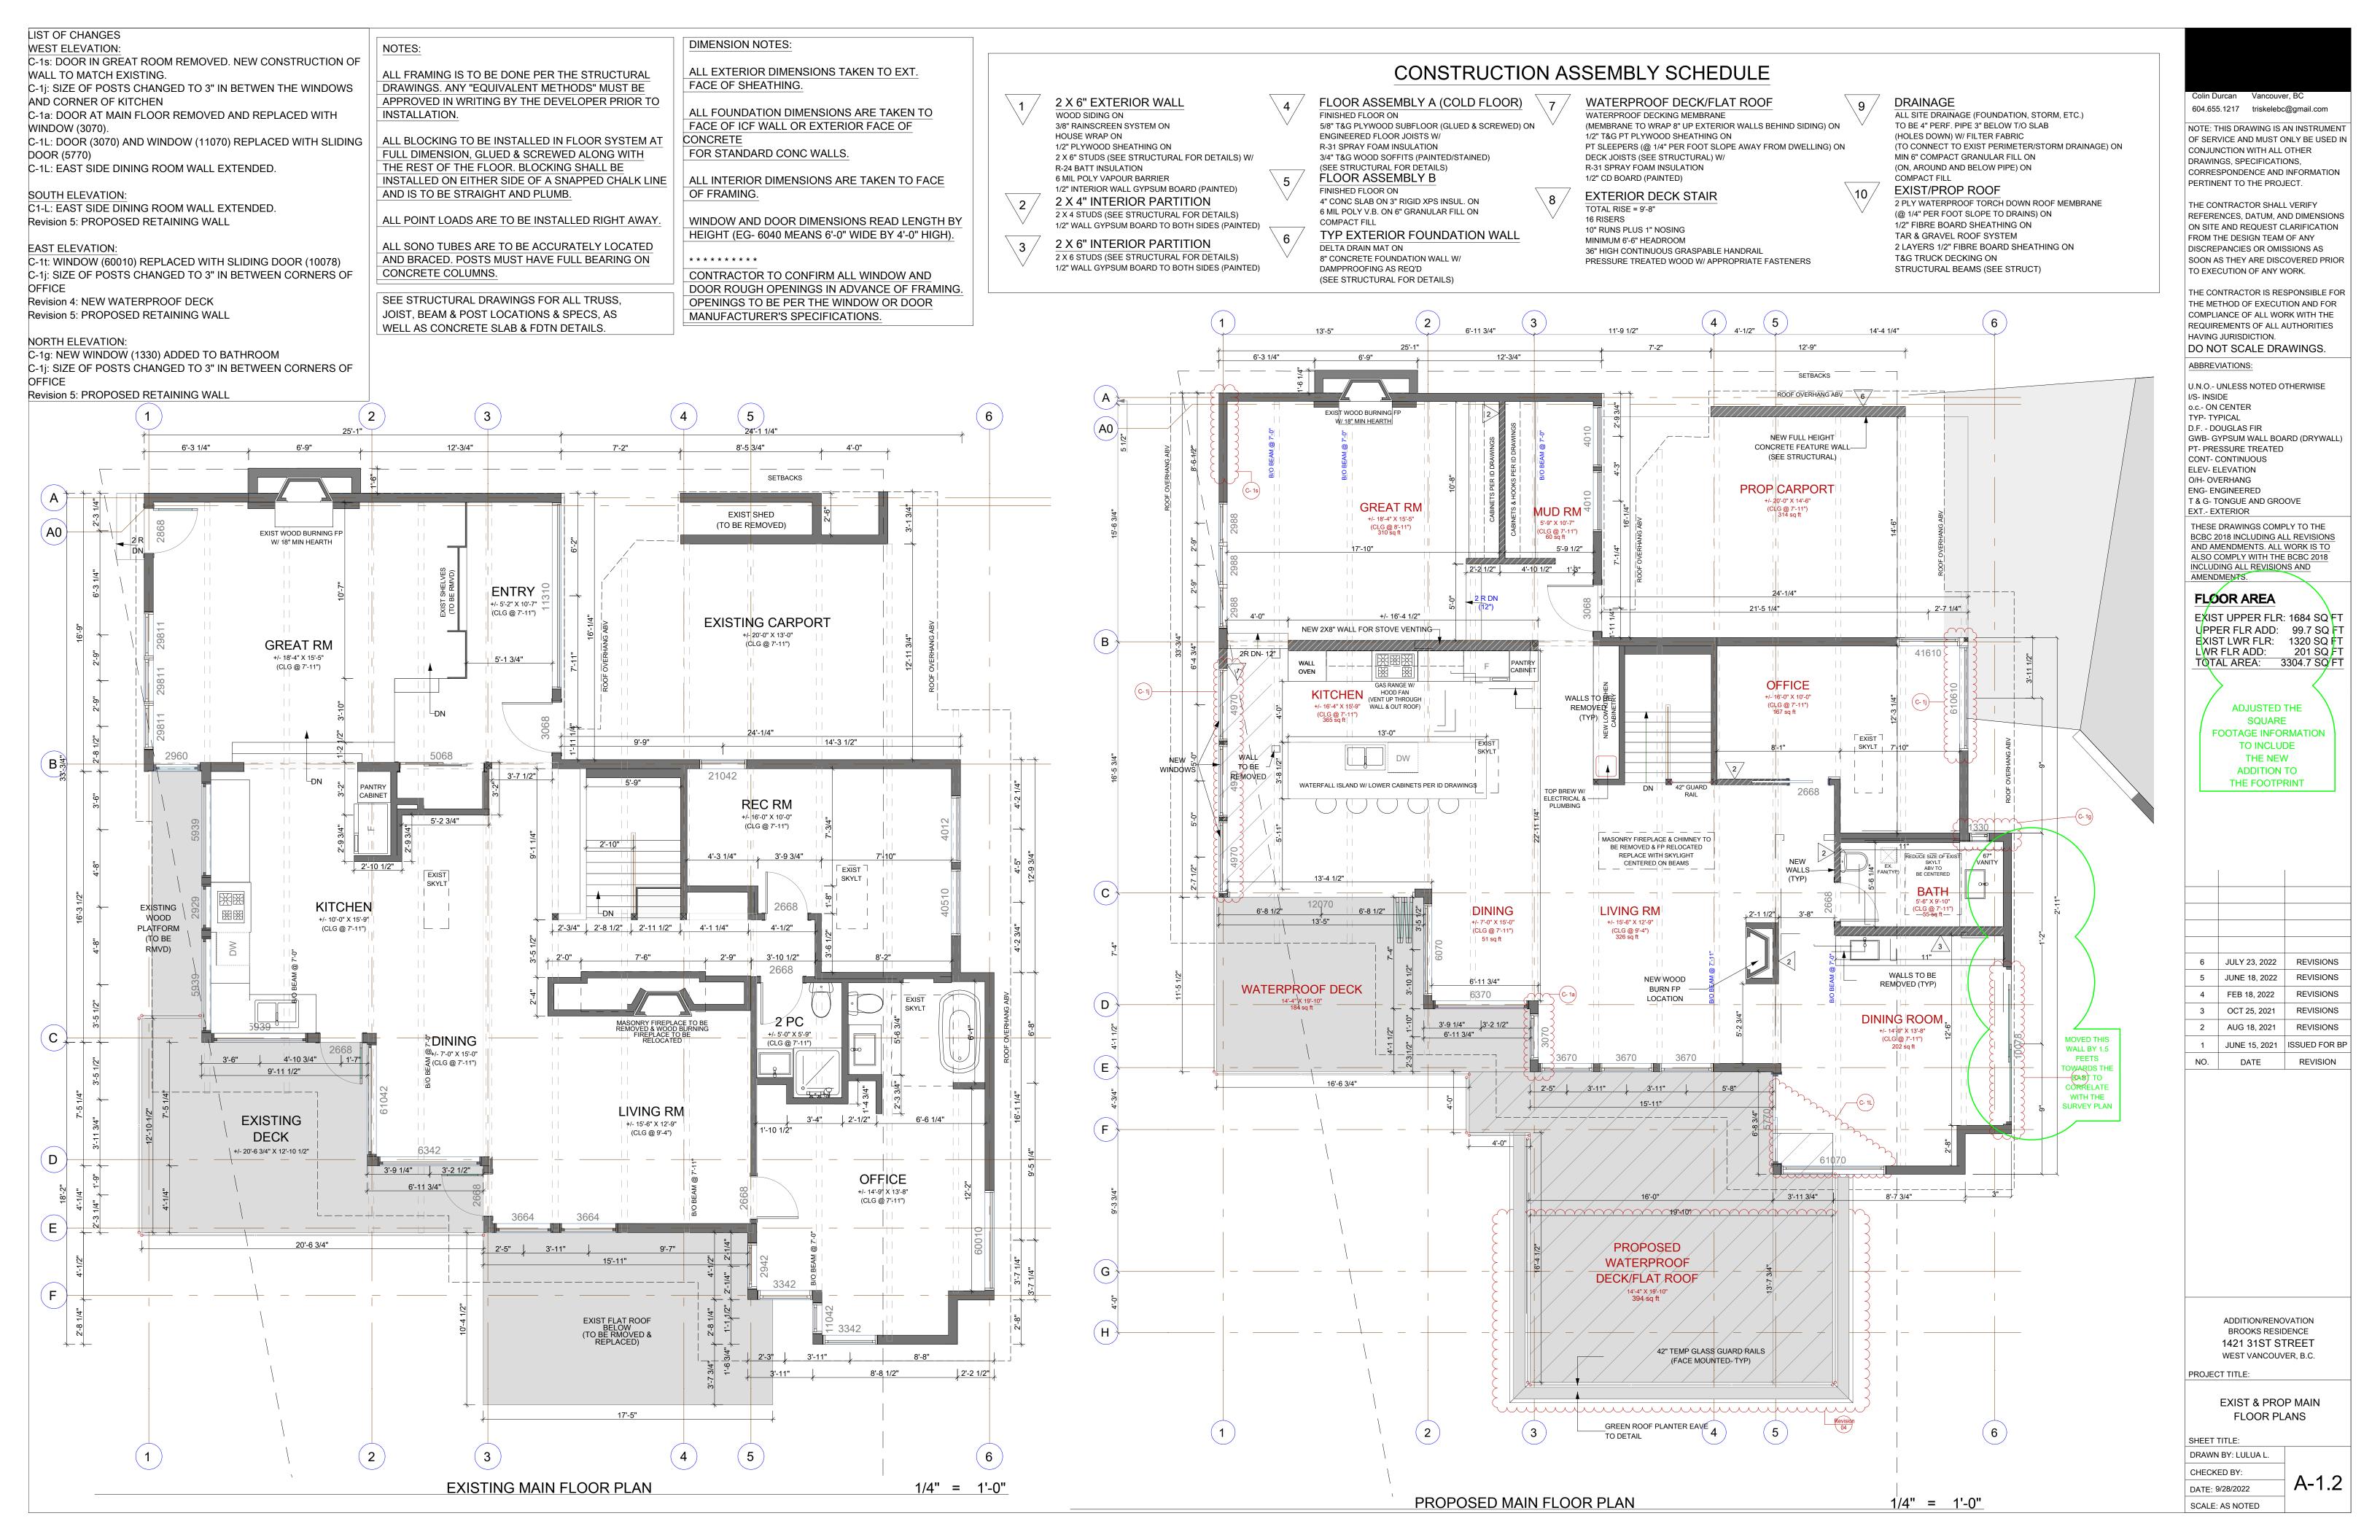

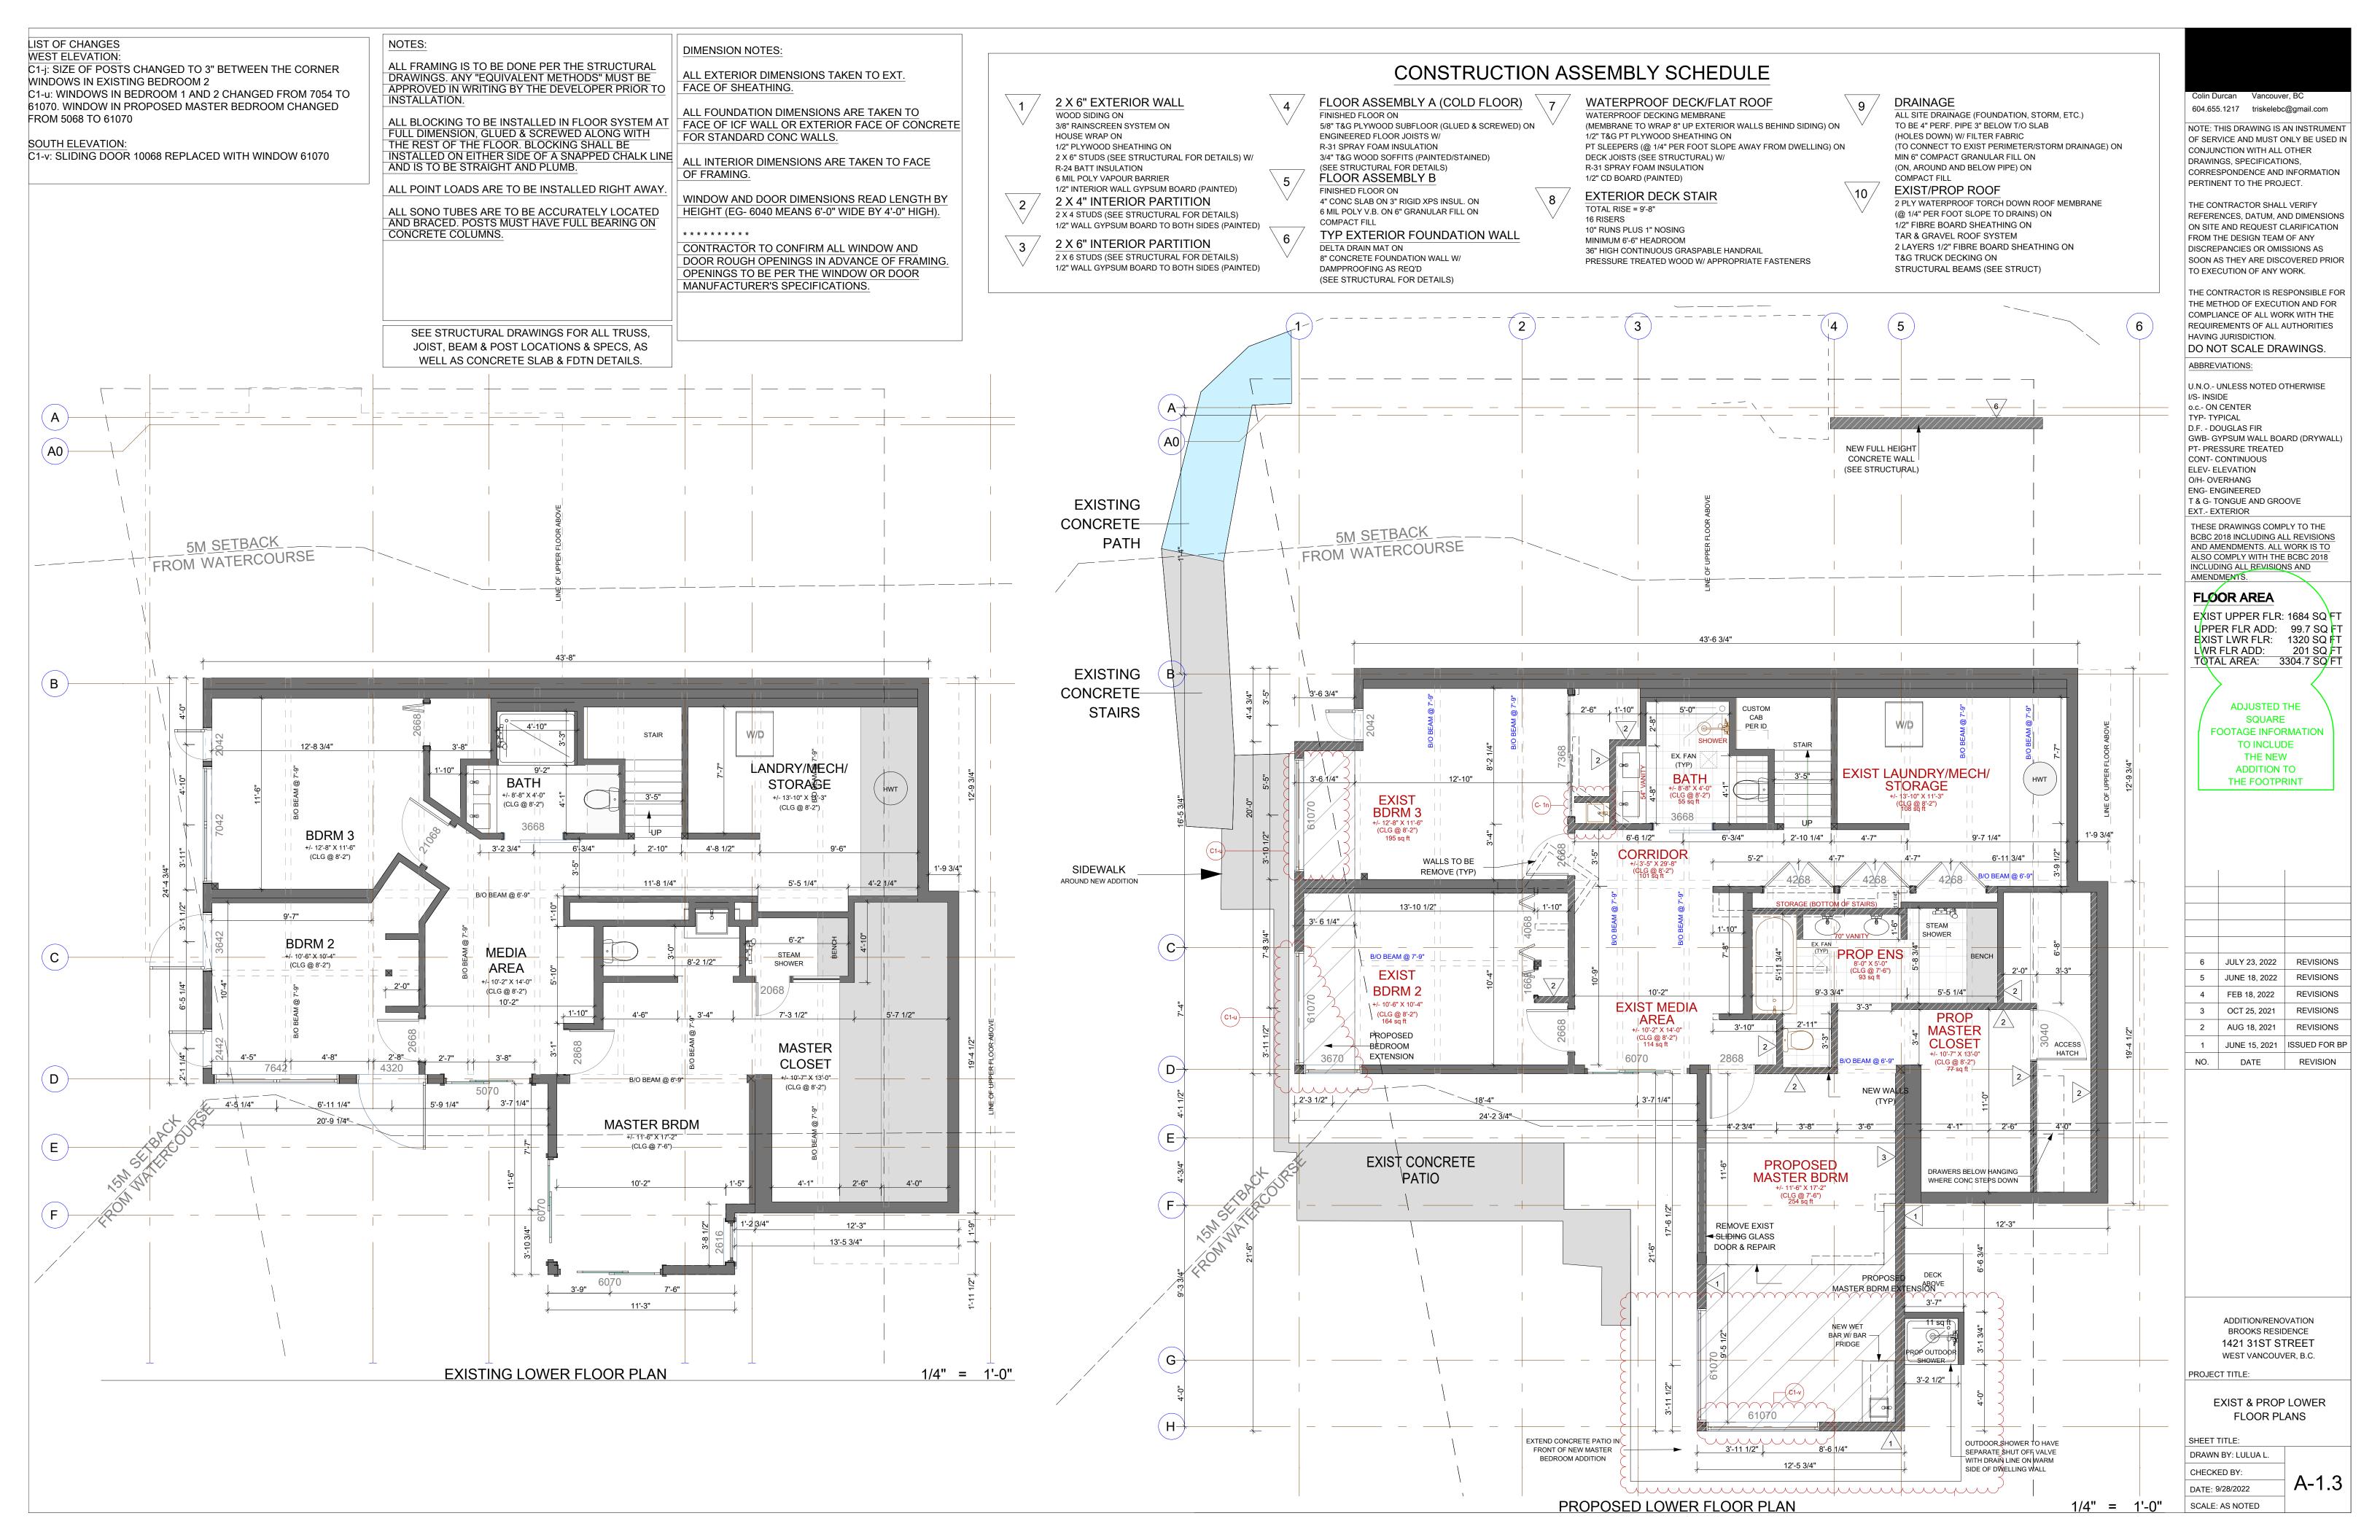

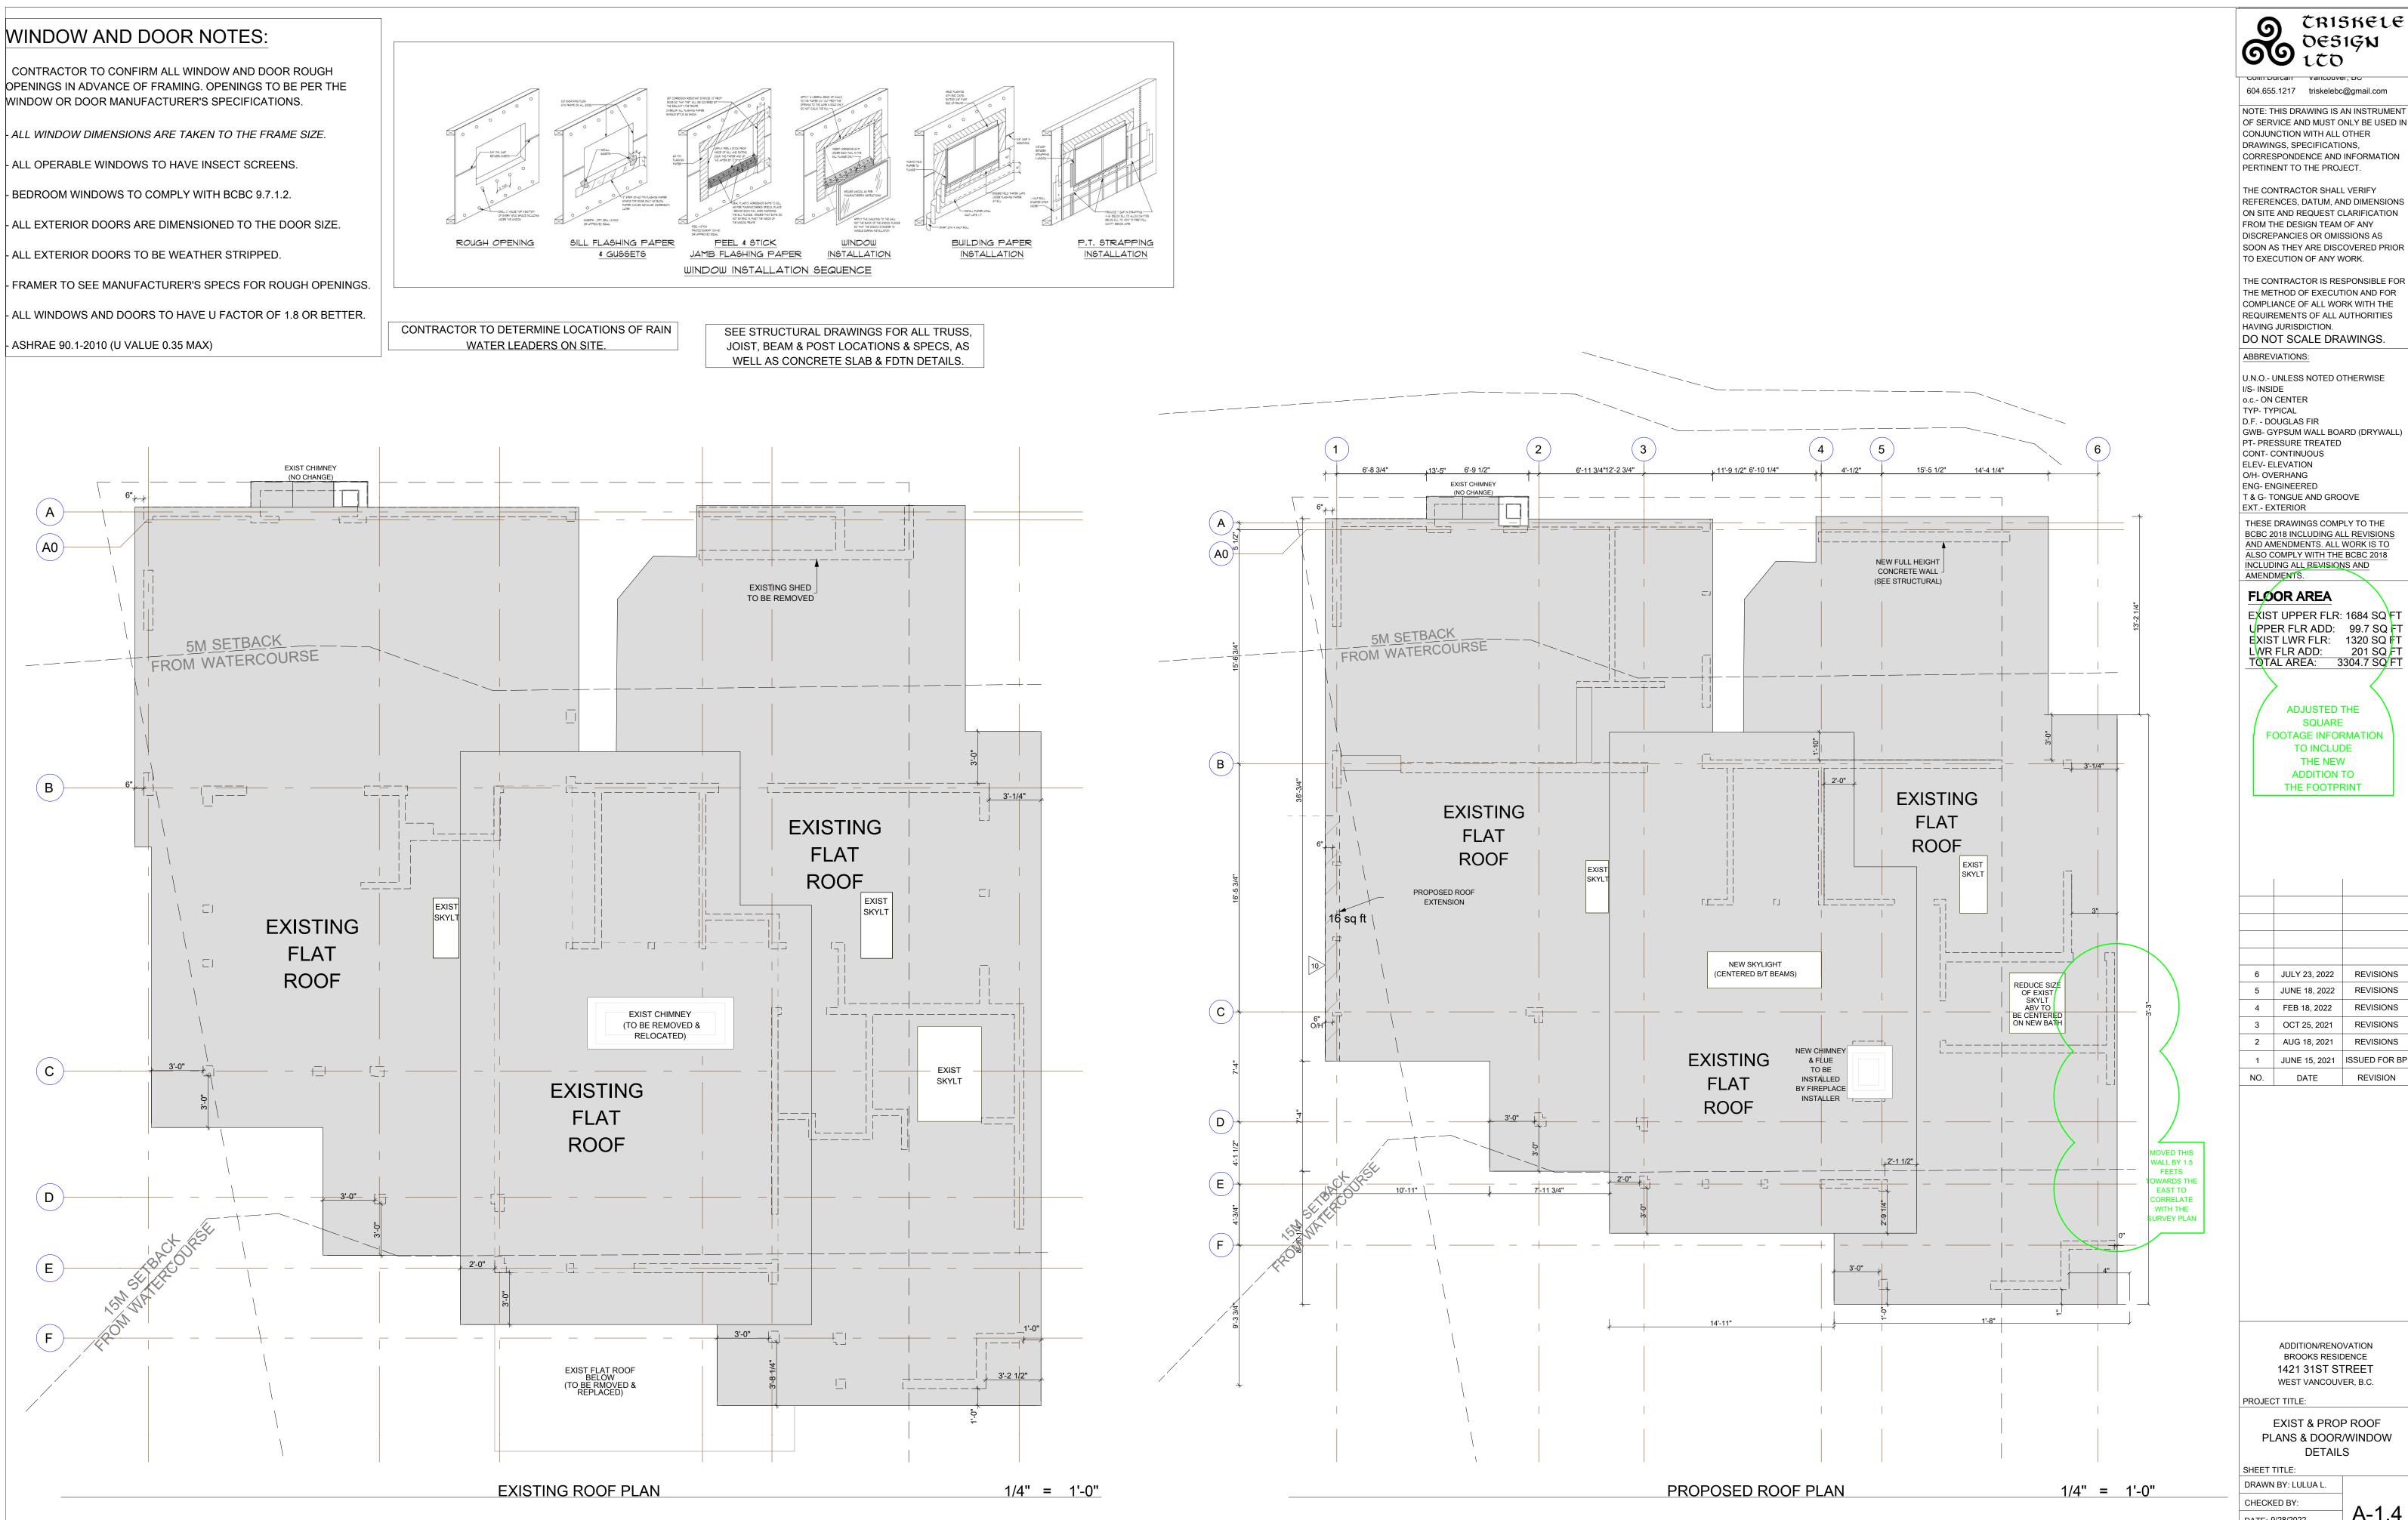



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COMPLIANCE OF ALL WORK WITH THE REQUIREMENTS OF ALL AUTHORITIES HAVING JURISDICTION. DO NOT SCALE DRAWINGS.

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TO INCLUDE THE NEW **ADDITION TO** THE FOOTPRINT

6 JULY 23, 2022 REVISIONS 5 JUNE 18, 2022 REVISIONS 4 FEB 18, 2022 3 OCT 25, 2021 REVISIONS 2 AUG 18, 2021 REVISIONS 1 JUNE 15, 2021 ISSUED FOR BF

DATE


ADDITION/RENOVATION BROOKS RESIDENCE 1421 31ST STREET WEST VANCOUVER, B.C.


EXIST & PROP ROOF PLANS & DOOR/WINDOW **DETAILS**

SHEET TITLE: DRAWN BY: LULUA L.

CHECKED BY:

A-1.4 DATE: 9/28/2022 SCALE: AS NOTED

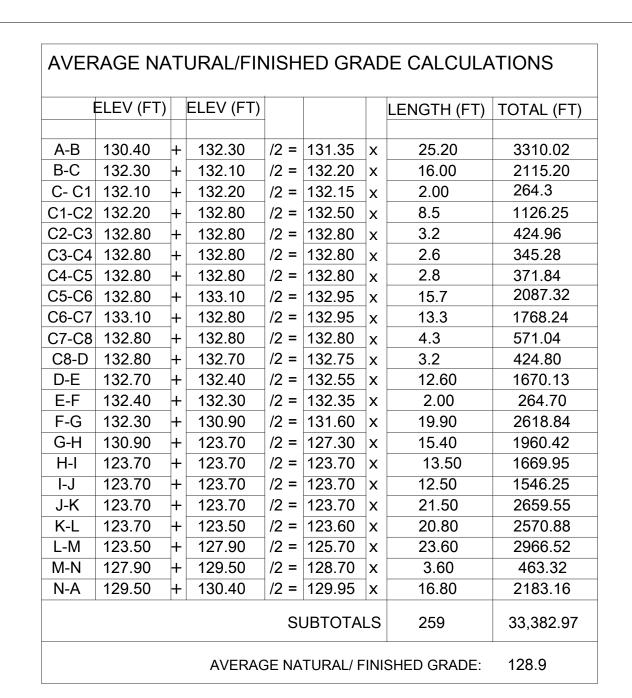

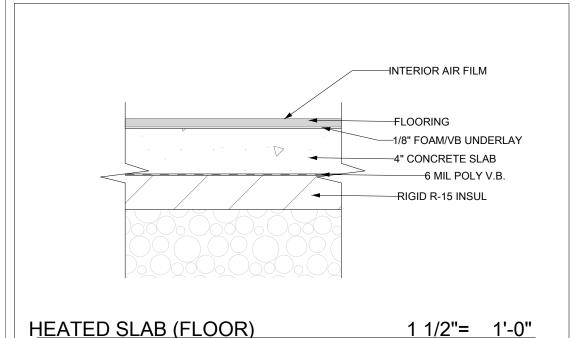

R-15 Rigid Slab	Interior air film	0.91	0.160	
	4" Reinforced Concreted Slab	0.23	0.041	
	R-15 Rigid Insulation	15.00	2.642	

EXTERIOR AIR FILM

HOUSE WRAP

6 mil Vapour barrier

---WOOD SIDING/CEMENTITIOUS SIDING


—1/2" RAINSCREEN PRODUCT

-5/8" PLYWOOD SHEATHING


6 MIL POLY V.B.

—2X6" STUDS W/ R-24 BATT

—1/2" DRYWALL (PAINTED)

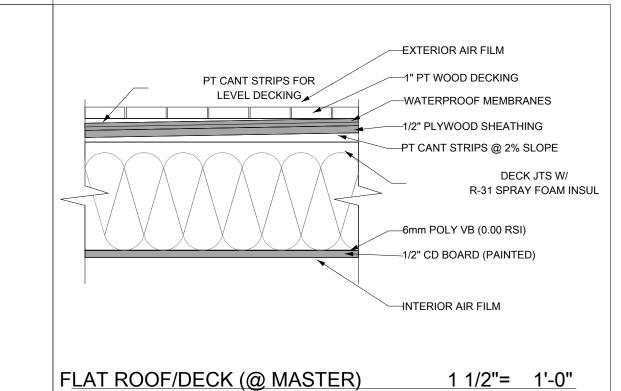

ABOV	E GRADE WAL	L 11	/2"=	1'-0"	_	
					Ш	2x10 @
tt	Exterior air film	0.17	0.030		Ш	
	Rain screen (½"– ¾" air space)	0.85	0.150			

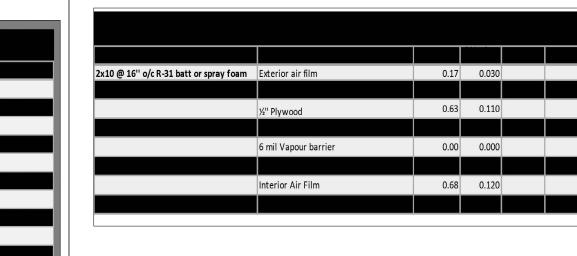

CONSTRUCTION ASSEMBLY SCHEDULE

2 X 6" EXTERIOR WALL WOOD SIDING ON 3/8" RAINSCREEN SYSTEM ON HOUSE WRAP ON 1/2" PLYWOOD SHEATHING ON 2 X 6" STUDS (SEE STRUCTURAL FOR DETAILS) W/ R-24 BATT INSULATION

6 MIL POLY VAPOUR BARRIER

2 X 4" INTERIOR PARTITION 2 X 4 STUDS (SEE STRUCTURAL FOR DETAILS) 1/2" WALL GYPSUM BOARD TO BOTH SIDES (PAINTED) 2 X 6" INTERIOR PARTITION 2 X 6 STUDS (SEE STRUCTURAL FOR DETAILS)

1/2" WALL GYPSUM BOARD TO BOTH SIDES (PAINTED)

1/2" INTERIOR WALL GYPSUM BOARD (PAINTED)

5/8" T&G PLYWOOD SUBFLOOR (GLUED & SCREWED) ON ENGINEERED FLOOR JOISTS W/ R-31 SPRAY FOAM INSULATION 3/4" T&G WOOD SOFFITS (PAINTED/STAINED) (SEE STRUCTURAL FOR DETAILS) FLOOR ASSEMBLY B FINISHED FLOOR ON

FINISHED FLOOR ON

4" CONC SLAB ON 3" RIGID XPS INSUL. ON 6 MIL POLY V.B. ON 6" GRANULAR FILL ON COMPACT FILL TYP EXTERIOR FOUNDATION WALL

FLOOR ASSEMBLY A (COLD FLOOR)

DELTA DRAIN MAT ON 8" CONCRETE FOUNDATION WALL W/ DAMPPROOFING AS REQ'D (SEE STRUCTURAL FOR DETAILS)

WATERPROOF DECK/FLAT ROOF WATERPROOF DECKING MEMBRANE (MEMBRANE TO WRAP 8" UP EXTERIOR WALLS BEHIND SIDING) ON 1/2" T&G PT PLYWOOD SHEATHING ON PT SLEEPERS (@ 1/4" PER FOOT SLOPE AWAY FROM DWELLING) ON

R-31 SPRAY FOAM INSULATION 1/2" CD BOARD (PAINTED) EXTERIOR DECK STAIR TOTAL RISE = 9'-8" 16 RISERS

DECK JOISTS (SEE STRUCTURAL) W/


10" RUNS PLUS 1" NOSING MINIMUM 6'-6" HEADROOM 36" HIGH CONTINUOUS GRASPABLE HANDRAIL PRESSURE TREATED WOOD W/ APPROPRIATE FASTENERS DRAINAGE


ALL SITE DRAINAGE (FOUNDATION, STORM, ETC.) TO BE 4" PERF. PIPE 3" BELOW T/O SLAB (HOLES DOWN) W/ FILTER FABRIC (TO CONNECT TO EXIST PERIMETER/STORM DRAINAGE) ON MIN 6" COMPACT GRANULAR FILL ON (ON, AROUND AND BELOW PIPE) ON COMPACT FILL

EXIST/PROP ROOF

2 PLY WATERPROOF TORCH DOWN ROOF MEMBRANE (@ 1/4" PER FOOT SLOPE TO DRAINS) ON 1/2" FIBRE BOARD SHEATHING ON TAR & GRAVEL ROOF SYSTEM 2 LAYERS 1/2" FIBRE BOARD SHEATHING ON T&G TRUCK DECKING ON STRUCTURAL BEAMS (SEE STRUCT)

> SEE STRUCTURAL DRAWINGS FOR ALL TRUSS, JOIST, BEAM & POST LOCATIONS & SPECS, AS WELL AS CONCRETE SLAB & FDTN DETAILS.

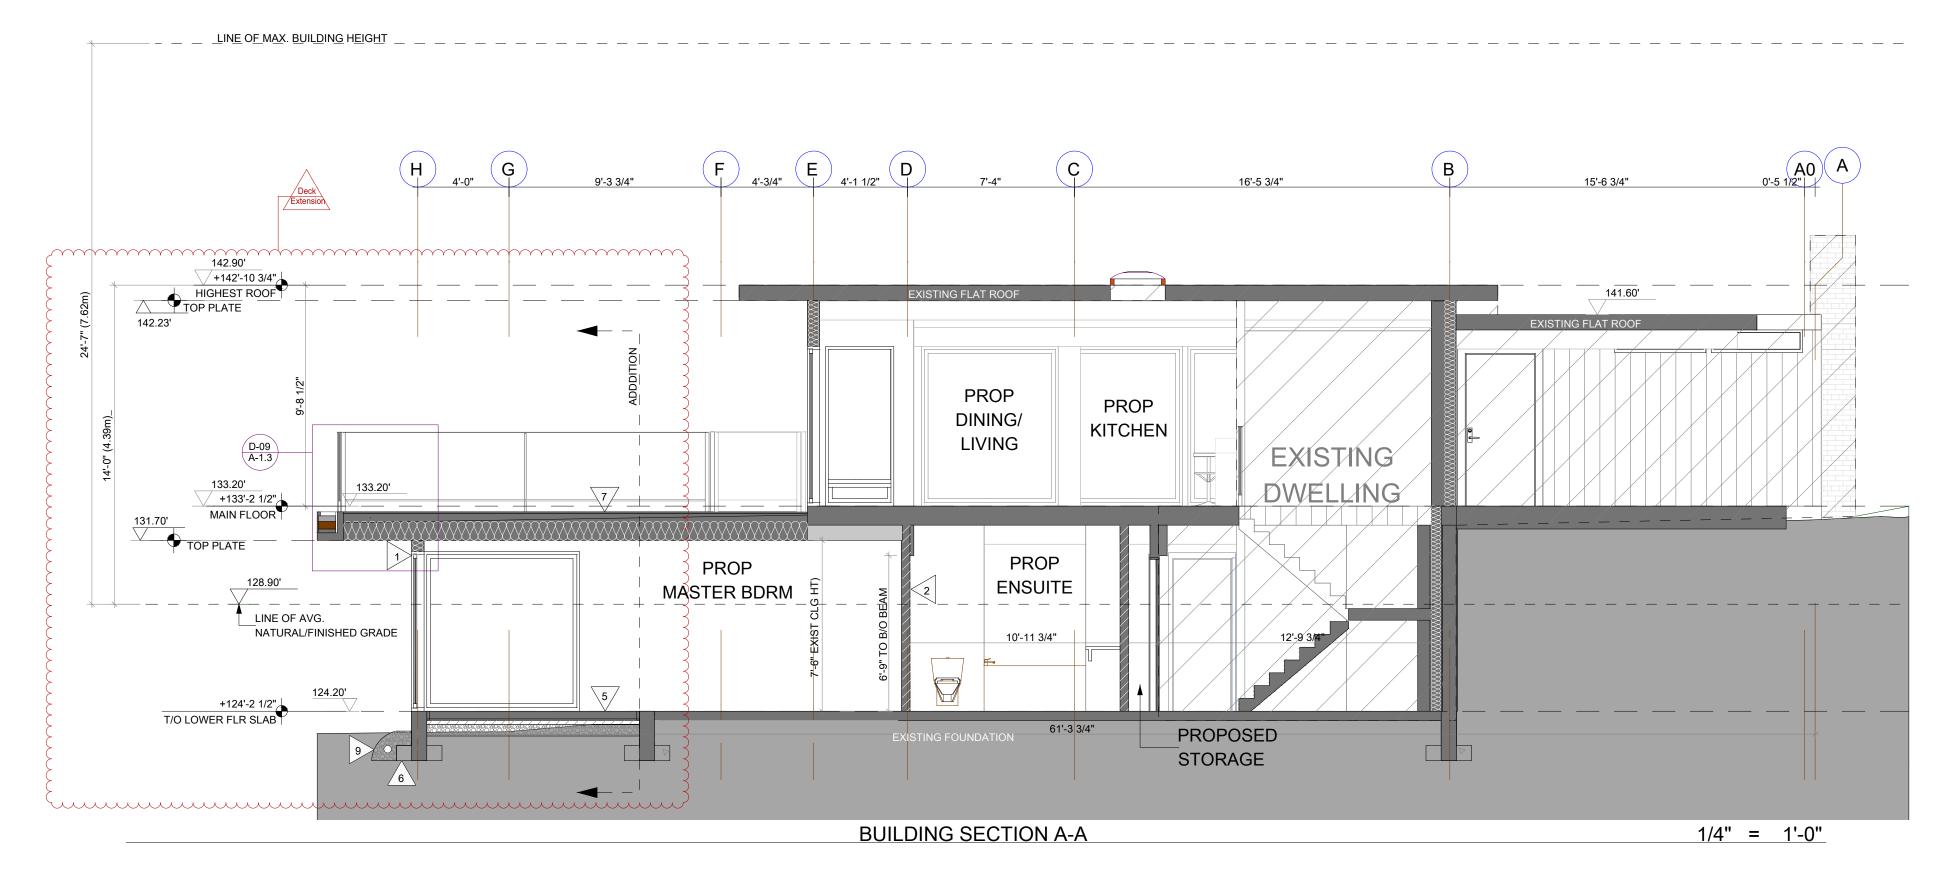

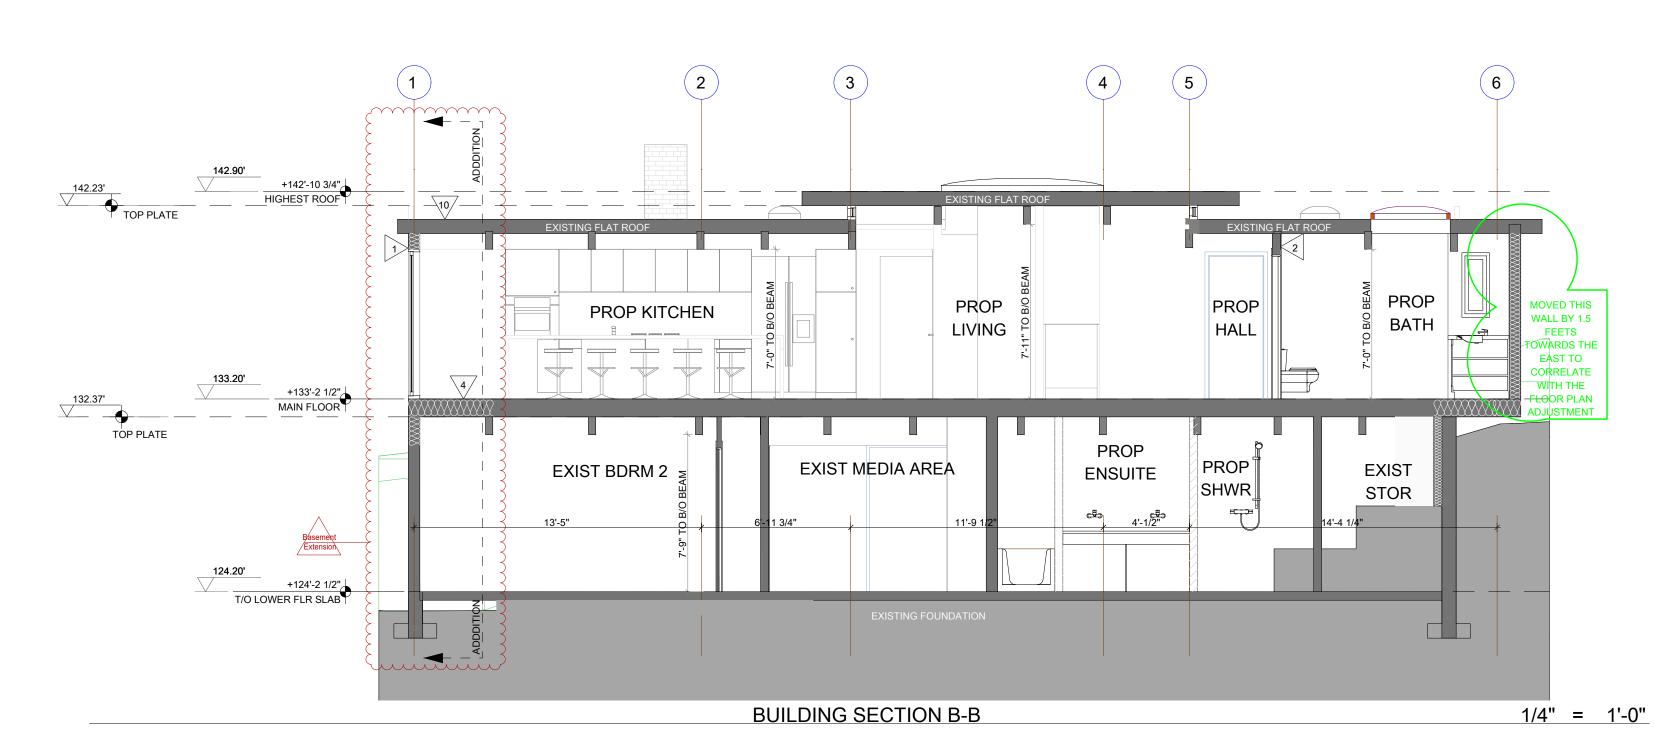

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COMPLIANCE OF ALL WORK WITH THE REQUIREMENTS OF ALL AUTHORITIES HAVING JURISDICTION.

THE CONTRACTOR IS RESPONSIBLE FOR

THE METHOD OF EXECUTION AND FOR

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AMENDMENTS. FLOOR AREA

EXIST UPPER FLR: 1684 SQ FT UPPER FLR ADD: 99.7 SQ FT EXIST LWR FLR: 1320 SQ FT LWR FLR ADD: 201 SQ FT TOTAL AREA: 3304.7 SQ/FT

ADJUSTED THE SQUARE FOOTAGE INFORMATION TO INCLUDE THE NEW ADDITION TO THE FOOTPRINT

6 JULY 23, 2022 REVISIONS 5 JUNE 18, 2022 REVISIONS FEB 18, 2022 3 OCT 25, 2021 REVISIONS AUG 18, 2021 REVISIONS JUNE 15, 2021 ISSUED FOR BP

DATE


ADDITION/RENOVATION BROOKS RESIDENCE 1421 31ST STREET WEST VANCOUVER, B.C.


BUILDING SECTIONS

PROJECT TITLE:

SHEET TITLE: DRAWN BY: LULUA L.

CHECKED BY: A-2.1 DATE: 9/28/2022 SCALE: AS NOTED

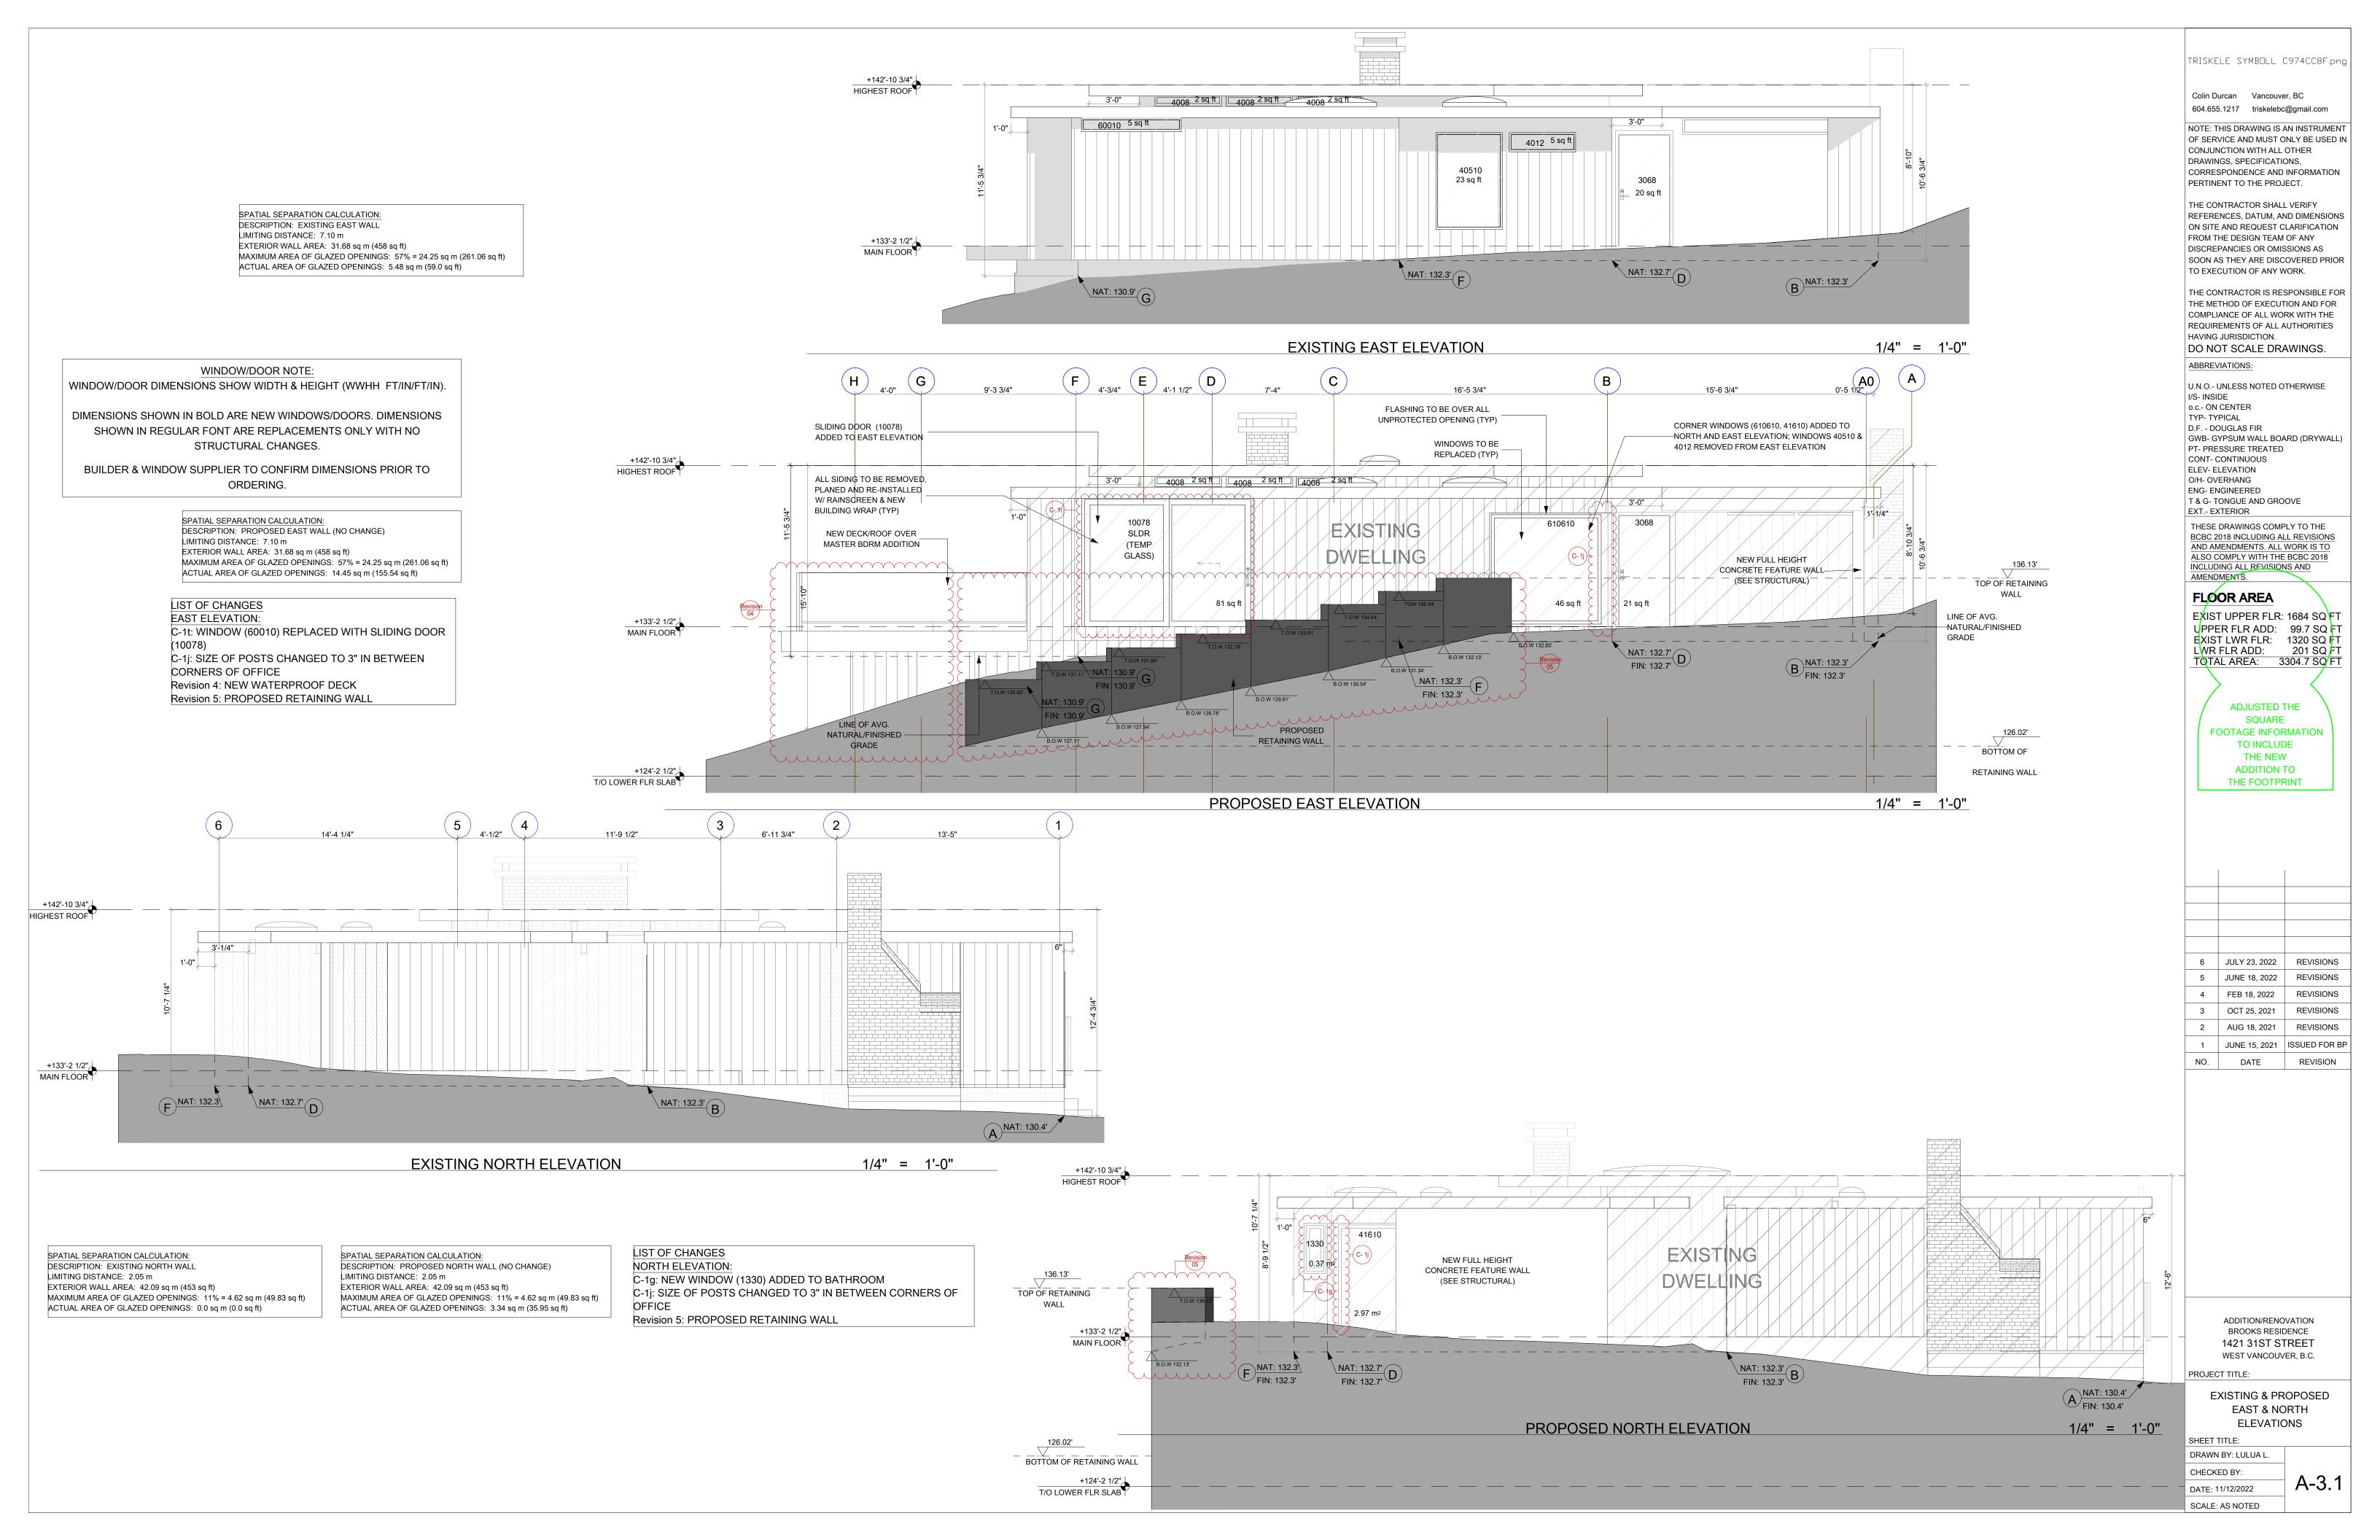


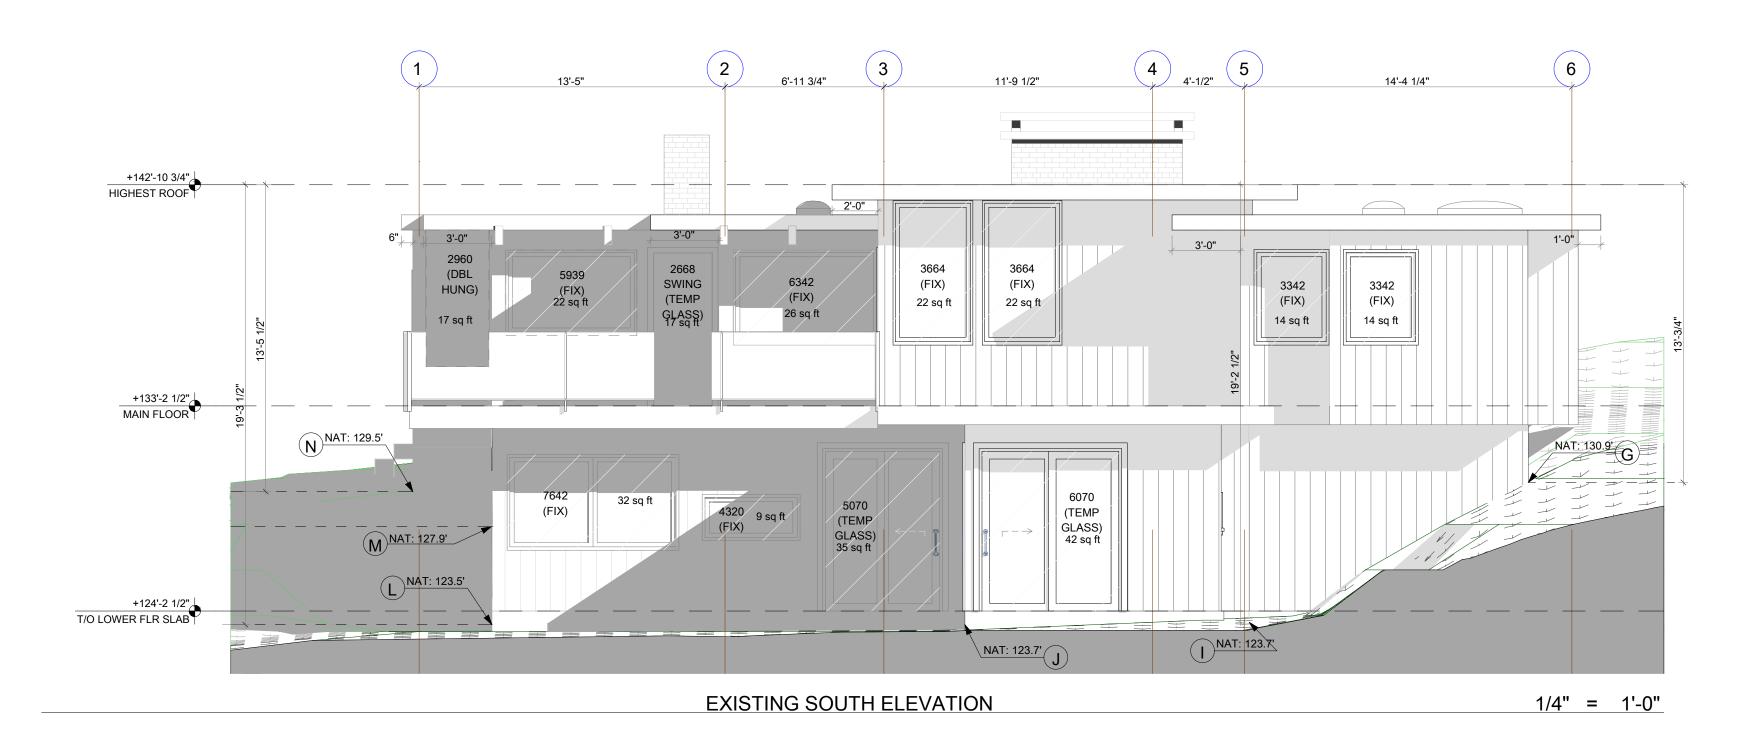

WINDOW/DOOR NOTE: WINDOW/DOOR DIMENSIONS SHOW WIDTH & HEIGHT (WWHH FT/IN/FT/IN).

DIMENSIONS SHOWN IN BOLD ARE NEW WINDOWS/DOORS. DIMENSIONS SHOWN IN REGULAR FONT ARE REPLACEMENTS ONLY WITH NO STRUCTURAL CHANGES. BUILDER & WINDOW SUPPLIER TO CONFIRM DIMENSIONS PRIOR TO ORDERING.

SPATIAL SEPARATION CALCULATION: DESCRIPTION: EXISTING SOUTH WALL LIMITING DISTANCE: 27.67 m EXTERIOR WALL AREA: 77.57 sq m (835 sq ft) MAXIMUM AREA OF GLAZED OPENINGS: 100% = 77.57 sq m (835 sq ft) ACTUAL AREA OF GLAZED OPENINGS: 25.27 sq m (272.0 sq ft)

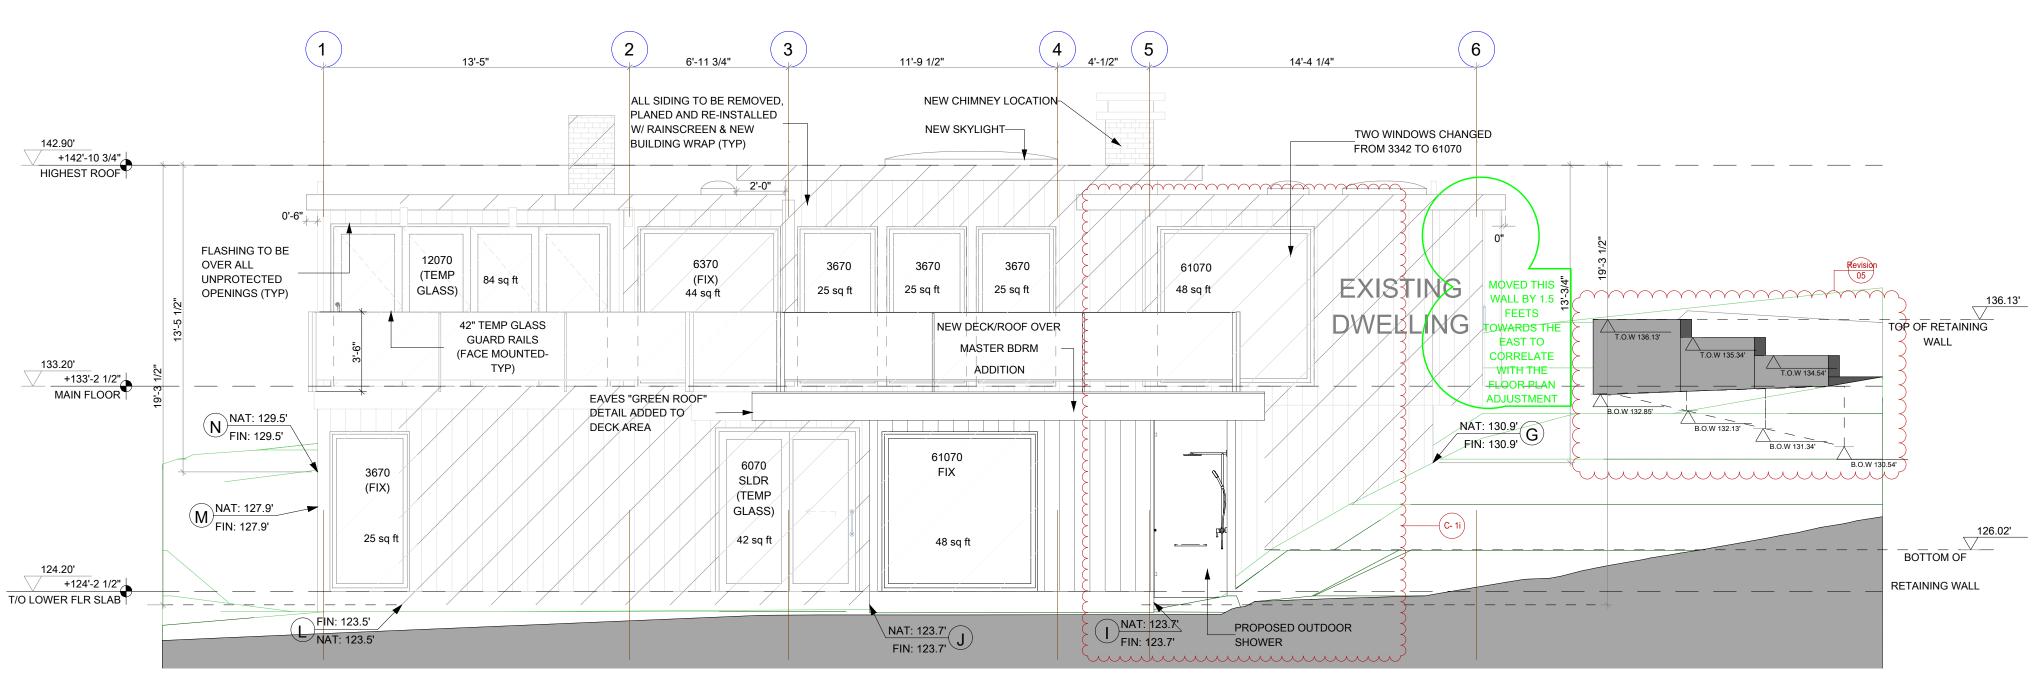

PROPOSED SOUTH ELEVATION

1/4" = 1'-0"

LIST OF CHANGES

SOUTH ELEVATION: C1i-: EAST SIDE DINING ROOM WALL EXTENDED. Revision 5: PROPOSED RETAINING WALL

SPATIAL SEPARATION CALCULATION: DESCRIPTION: PROPOSED SOUTH WALL LIMITING DISTANCE: 27.67 m EXTERIOR WALL AREA: 77.57 sq m (835 sq ft) MAXIMUM AREA OF GLAZED OPENINGS: 100% = 77.57 sq m (835 sq ft) ACTUAL AREA OF GLAZED OPENINGS: 33.80 sq m (363.82 sq ft)

TRISKELE SYMBOLL C974CC8F.png

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NO.	DATE	REVISION
	•	

ADDITION/RENOVATION BROOKS RESIDENCE 1421 31ST STREET WEST VANCOUVER, B.C.

PROJECT TITLE:

EXISTING & PROPOSED SOUTH ELEVATIONS

SHEET TITLE: DRAWN BY: LULUA L.

CHECKED BY:

A-3.2

DATE: 11/12/2022 SCALE: AS NOTED



WINDOW/DOOR NOTE: WINDOW/DOOR DIMENSIONS SHOW WIDTH & HEIGHT (WWHH FT/IN/FT/IN). DIMENSIONS SHOWN IN BOLD ARE NEW WINDOWS/DOORS. DIMENSIONS SHOWN IN REGULAR FONT ARE REPLACEMENTS ONLY WITH NO STRUCTURAL CHANGES. BUILDER & WINDOW SUPPLIER TO CONFIRM DIMENSIONS PRIOR TO ORDERING.

15'-6 3/4" 16'-5 3/4" 0'-5 1/2" ALL SIDING TO BE REMOVED. PLANED AND RE-INSTALL MPROTECTED OPENINGS WINDOWS TO BE W/ RAINSCREEN & NEW NEW CHIMNEY LOCATION BUILDING WRAP (TYP) REPLACED (TYP) +142'-10 3/4" HIGHEST ROOF 40080.225 m² 40080.225 m² 40080.225 m² 5770 3070 4970 4970 4970 SLIDING 2988 2988 2988 FIX (FIX) (FIX) (FIX) (FIX) (TEMP NEW DECK/ROOF (FIX) (FIX) (TEMP (TEMP 3.902 m² (TEMP (TEMP (TEMP OVER MASTER BDRM GLASS) (TEMP (TEMP (TEMP GLASS) GLASS) GLASS) GLASS) GLASS) ADDITION GLASS) GLASS) GLASS) 4.178 m² 1.951 m² 2.926 m² 2.926 m² 3.089 m² 6.643 m² 42" TEMP GLASS GUARD RAILS (FACE MOUNTED- TYP) 133.20' m +133'-2 1/2" MAIN FLOOR NAT: 130.4' FIN: 130.4' SLIDING GLASS DOOR NAT: 129.5' FIN: 129.5' REMOVED)/ 61070 61070 61070 2042 (FIX) (FIX) (FIX) (CSMNT) (TEMP GLASS) DWELLING MAT: 127.9' FIN: 127.9' 4.444 m² 4.444 m² 4.444 m² NAT: 123.5' FIN: 123.5' 124.20' m +124'-2 1/2"
T/O LOWER FLR SLAB BASEMENT WEST WALL EXTENDED TO CASEMENT WINDOWS (61070, NAT: 123.7' FIN: 123.7' MEET UPPER FLOOR'S WEST WALL 61070) ADDED TO WEST ELEVATION; WINDOWS 7042 REMOVED

PROPOSED WEST ELEVATION

LIST OF CHANGES

WEST ELEVATION:

WINDOW (3070)

DOOR (5770)

AND CORNER OF KITCHEN

C-1s: DOOR IN GREAT ROOM REMOVED.

C-1L: EAST SIDE DINING ROOM WALL EXTENDED.

C-1j: SIZE OF POSTS CHANGED TO 3" IN BETWEN THE WINDOWS

C-1L: DOOR (3070) AND WINDOW (11070) REPLACED WITH SLIDING

C-1a: DOOR AT MAIN FLOOR REMOVED AND REPLACED WITH

SPATIAL SEPARATION CALCULATION: DESCRIPTION: PROPOSED WEST WALL LIMITING DISTANCE: 7.85 m EXTERIOR WALL AREA: 72.55 sq m (781 sq ft) MAXIMUM AREA OF GLAZED OPENINGS: 57% = 41.36 sq m (445.17 sq ft) ACTUAL AREA OF GLAZED OPENINGS: 38.57 sq m (415.16 sq ft)

SPATIAL SEPARATION CALCULATION:

DESCRIPTION: EXISTING WEST WALL

EXTERIOR WALL AREA: 68.10 sq m (733 sq ft)

MAXIMUM AREA OF GLAZED OPENINGS: 100% = 68.10 sq m (733 sq ft)

ACTUAL AREA OF GLAZED OPENINGS: 29.36 sq m (316.0 sq ft)

LIMITING DISTANCE: 8.78 m

1/4" = 1'-0"

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ADDITION/RENOVATION **BROOKS RESIDENCE** 1421 31ST STREET WEST VANCOUVER, B.C.

PROJECT TITLE:

EXISTING & PROPOSED WEST ELEVATIONS

SHEET TITLE: DRAWN BY: LULUA L.

CHECKED BY: A-3.3

DATE: 9/28/2022

SCALE: AS NOTED