

PID: 008-424-250

CIVIC ADDRESS:
534 BALLANTREE ROAD, WEST VANCOUVER, BC

ADDRESS	534 BALLANTREE RD., WEST VANCOUVER					
	ZONING		ALLOWED ZONING PROVISIONS FOR HIGH PERFORMANCE BUILDINGS STEP CODE LEVEL 4 (120.29)		PROPOSED	
	IMP	MET	IMP	MET	IMP	MET
LOT AREA	14,695	1,365.2	14,695	1,365.2		
SITE WIDTH	100.91	30.76	100.91	30.76		
SITE COVERAGE	4,585	425.9	4,585	425.9	3,022	280.8
FAR	5,349	496.9	5,349	496.9	5,160	479.3
UPPER LEVEL					2,565	238.3
MAIN LEVEL					2,990	277.8
INCLUDING GARAGE					440	40.9
BASEMENT TOTAL					2,990	277.8
BASEMENT EXCLUDED FROM FAR CALCULATIONS (TOP OF FLOOR ABOVE < 0.9M)					2,735	254.1
BASEMENT PARTIALLY INCLUDED IN FAR CALCULATIONS					255	23.7
FAR INCLUDED 17.49%					45	4.1
FAR EXCLUDED 82.51%					2,104	195
TOTAL AREA					5,810	539.8
FRONT YARD SETBACK	29.86	9.10	29.36	8.95	29.86	9.10
SIDE YARD SETBACK MINIMUM	9.84	3.00	9.35	2.85	17.76	5.41
COMBINED SIDE YARD SETBACK	25.27	7.69	24.24	7.39	45.58	13.89
SETBACK	15.38	4.69	14.89	4.54	27.82	8.48
REAR YARD SETBACK	29.86	9.10	29.36	8.95	14.14	4.31
MAX BUILDING HEIGHT	25.00	7.62	25.50	7.77	25.00	7.62
HIGHEST BUILDING FACE	22.00	6.71	22.50	6.86	22.50	6.86

BASEMENT EXCLUSION	
AVERAGE GRADE	1048.50
MAIN LEVEL	1050.25
BASEMENT	1040.25
EXCLUSION	82.51

NATURAL AVERAGE GRADE CALCULATIONS

E1 E2	1052.10 + 1051.90 / 2 X	23.06 =	24,259.1
E2 E3	1051.90 + 1052.10 / 2 X	6.08 =	6,396.2
E3 E4	1052.10 + 1052.10 / 2 X	5.48 =	5,765.5
E4 E5	1052.10 + 1052.10 / 2 X	2.00 =	2,104.2
E5 E6	1052.10 + 1051.90 / 2 X	14.15 =	14,883.0
E6 E7	1051.90 + 1051.60 / 2 X	1.33 =	1,398.6
E7 E8	1051.60 + 1049.30 / 2 X	17.02 =	17,878.7
E8 E1	1049.30 + 1050.30 / 2 X	13.49 =	14,161.8
E1 E2	1050.30 + 1046.20 / 2 X	14.83 =	15,545.5
E2 E3	1046.20 + 1046.40 / 2 X	17.63 =	18,446.3
E3 E4	1046.40 + 1042.10 / 2 X	14.92 =	15,580.2
E4 E5	1042.10 + 1046.10 / 2 X	27.25 =	28,451.7
E5 W1	1046.10 + 1048.10 / 2 X	15.68 =	16,418.9
W1 W2	1048.10 + 1050.30 / 2 X	21.27 =	22,316.5
W2 W3	1050.30 + 1050.70 / 2 X	6.21 =	6,523.6
W3 W4	1050.70 + 1051.40 / 2 X	14.54 =	15,282.3
W4 W5	1051.40 + 1051.80 / 2 X	8.10 =	8,518.0
W5 W6	1051.80 + 1052.30 / 2 X	20.10 =	21,146.2
W6 W7	1052.30 + 1051.60 / 2 X	7.00 =	7,363.7
W7 W8	1051.60 + 1053.30 / 2 X	9.56 =	10,061.4
W8 W9	1053.30 + 1056.50 / 2 X	7.30 =	7,700.8
W9 E1	1056.50 + 1052.10 / 2 X	19.98 =	21,064.9
		286.98	301,266.5
			1049.78

FINISHED AVERAGE GRADE CALCULATIONS

E1 E2	1050.25 + 1050.25 / 2 X	23.06 =	24,218.8
E2 E3	1050.25 + 1049.75 / 2 X	6.08 =	6,384.0
E3 E4	1049.75 + 1049.75 / 2 X	5.48 =	5,752.6
E4 E5	1049.75 + 1049.75 / 2 X	2.00 =	2,099.9
E5 E6	1049.75 + 1049.75 / 2 X	14.15 =	14,854.0
E6 E7	1049.75 + 1049.75 / 2 X	1.33 =	1,396.2
E7 E8	1049.75 + 1049.75 / 2 X	17.02 =	17,866.7
E8 E1	1049.75 + 1049.75 / 2 X	13.49 =	14,161.1
E1 E2	1049.75 + 1049.75 / 2 X	14.83 =	15,567.8
E2 E3	1049.75 + 1049.75 / 2 X	17.63 =	18,507.1
E3 E4	1049.75 + 1039.75 / 2 X	14.92 =	15,587.7
E4 E5	1039.75 + 1039.75 / 2 X	27.25 =	28,333.2
E5 W1	1049.75 + 1049.75 / 2 X	15.68 =	16,430.7
W1 W2	1049.75 + 1049.75 / 2 X	21.27 =	22,328.2
W2 W3	1049.75 + 1049.75 / 2 X	6.21 =	6,518.9
W3 W4	1049.75 + 1049.75 / 2 X	14.54 =	15,263.4
W4 W5	1049.75 + 1049.75 / 2 X	8.10 =	8,503.0
W5 W6	1049.75 + 1049.75 / 2 X	20.10 =	21,100.0
W6 W7	1049.75 + 1049.75 / 2 X	7.00 =	7,348.3
W7 W8	1049.75 + 1049.75 / 2 X	9.56 =	10,035.6
W8 W9	1049.75 + 1049.75 / 2 X	7.30 =	7,663.2
W9 E1	1049.75 + 1050.25 / 2 X	19.98 =	20,979.0
		286.98	300,898.8
			1048.50



Site Plan
1/8" = 1'-0"

- GENERAL NOTES**
- LUMBER**
SEE STRUCTURAL NOTES FOR DETAILS.
- CONCRETE**
SEE STRUCTURAL NOTES FOR DETAILS.
- GENERAL**
- GENERAL CONTRACTOR TO CHECK AND VERIFY ALL DRAWINGS, DIMENSIONS, AND ELEVATIONS BEFORE COMMENCING WORK. REPORT ANY DISCREPANCY TO THE DESIGNER.
 - DRAWINGS ARE NOT TO BE SCALED.
 - CONSTRUCTION METHODS AND TECHNOLOGIES TO CONFIRM REQUIREMENTS OF BCBD 2018.
 - MATERIALS TO BE USED IN STRICT ACCORDANCE WITH MANUFACTURER'S RECOMMENDATIONS.
 - TREE REMOVAL TO BE GOVERNED BY LOCAL AUTHORITIES.
 - GENERAL CONTRACTOR SHALL PASS ALL NECESSARY INSPECTIONS.
- VENTILATION**
- UNIFORMLY DISTRIBUTE VENTILATION TO FLAT AND VAULTED ROOFS TO 1/150 OF INSULATED CEILING AREA. VENTING IS REQUIRED TO BE TWO-WAY.
 - MIN. 2" X 2" CROSS-PULING TO FLAT, VAULTED CEILING, AND DECK OVER LIVING AREAS TO CONFORM TO #9, 19, 1, 2.
 - PROVIDE MIN. 2" CLEARANCE BETWEEN ROOF SHEATHING AND INSULATION #9, 19, 1, 3. PROVIDE MIN. 1" CLEARANCE BETWEEN INSULATION AND TOP OF ROOF JOISTS.
 - VENTILATE ATTICS TO 1/300 OF INSULATED CEILING AREA.
 - ROOF VENTS MUST BE UNIFORMLY DISTRIBUTED WITH A MINIMUM OF 25% AT BARE AND 25% IN ROOFTOP.
 - PROVIDE ATTIC HATCH OF 3.45F IN AREA WITH NO DIMENSIONS LESS THAN 1'10"
 - SUBMIT MECHANICAL VENTILATION/ AIR CONDITIONING DESIGN AND LETTER OF SUPERVISION BY PROFESSIONAL ENGINEER, CERTIFIED HRAI OR HVAC TECHNICIAN.
 - CONTINUOUS OR INTERMITTENT EXHAUST FANS ARE REQUIRED TO ALL BATHROOMS AND KITCHENS AS PER #9, 32, 3, 3.
- STAIRS**
- STRAIGHT STAIR: RISE MIN. 5" MAX. 7.87" RUN MIN. 8.25" MAX. 14"
 - MAXIMUM 1" NOSING ON STAIR TREADS.
 - MINIMUM HEADROOM IS 6'-5" FROM A LINE THROUGH NOSING, MEASURED VERTICALLY.
 - HANDRAIL TO BE BETWEEN 35" TO 38" FROM A LINE, MEASURED VERTICALLY, THROUGH NOSING.
 - PRIMARY STAIR MINIMUM WIDTH 5'10"
 - HANDRAIL REQ'D ON INTERIOR STAIRS WITH THREE OR MORE RISERS.
 - HANDRAIL AS A GUARD IS TO BE BETWEEN 36" AND 42"
- CHIMNEY & FIREPLACES**
- MINIMUM 2" CLEARANCE BETWEEN CHIMNEY AND COMBUSTIBLE FRAMING.
 - MINIMUM 2" CLEARANCE BETWEEN FIREPLACE AND COMBUSTIBLE FRAMING.
 - HAND WIRE D.C. DETECTOR ARE REQUIRED IN EACH BEDROOM OR WITHIN 5 METERS OF EACH BEDROOM DOOR IN CONFORMANCE WITH #9, 32, 4, 2

- GUARDRAILS**
- GUARDRAILS TO BE A MINIMUM 42" EXTERIOR AND 36" INTERIOR HEIGHT.
 - NO MEMBER FACILITATING CLIMBING PERMITTED FROM 5'10" TO 36" ABOVE THE FLOOR OR WALKING SURFACE (IN ALL GUARDS).
 - MAXIMUM 4" OPENING IN ALL STAIR, DECK AND BALCONY GUARDS (INTERIOR AND EXTERIOR).
 - ALL GLASS GUARDS TO HAVE TOP CAP UNLESS APPROVED BY PROF. ENGINEER.
 - A MINIMUM OF 36" IN HEIGHT IS PERMITTED FOR DECKS WITHIN 5'-11" OF GRADE.
 - GLASS GUARDS TO HAVE MINIMUM 4" CLEARANCE TO BALCONY OR DECK.
 - WHERE A PROTECTIVE ENCLOSURE IS INSTALLED OVER A WINDOW WELL, IT SHALL BE OPERABLE FROM THE INSIDE WITHOUT THE USE OF KEYS, TOOLS, OR SPECIAL KNOWLEDGE.
- GLAZING**
- GLASS IN WINDOWS AND DOORS TO BE DOUBLE-GLAZED.
 - GLASS IN ENTRANCE, SHOWER AND BATHING DOORS, AND WINDOWS WITHIN 8" OF FLOORS AND WITHIN 36" OF DEAD BOLTS ARE ALL TO BE SAFETY GLASS.
 - SLIDING DOORS 20" IN WIDTH ARE TO BE SAFETY GLASS.
 - WINDOWS IN WALLS ENCLOSED SHOWERS OR TUBS ARE TO BE SAFETY GLASS AND BE LOCATED ABOVE THE WATERPROOF WALL FINISH HEIGHT.
 - THE BOTTOM OF AN OPERABLE WINDOW IN A BEDROOM IS NOT TO EXCEED 4'-11" ABOVE THE FLOOR, AND HAVE A MIN. OPENING WIDTH OF 1'0" WITH AN AREA OF 3.75M².
 - UNLESS THE HOUSE IS SPRINKLERED.
 - WINDOWS OVER STAIRS, BATHS AND LANDINGS THAT EXTEND TO LESS THAN 36" ABOVE THE SURFACE SHALL BE PROTECTED WITH GUARDS OR BE NON-OPERABLE AND DESIGNED TO #4, 1, 5, 15.
 - WINDOW WELLS ARE TO BE 2' MINIMUM WIDTH WHEN REQUIRED AS A BEDROOM EGRESS.
 - BEDROOM WINDOWS REQUIRED AS EXITS MUST MAINTAIN THE REQUIRED OPENING DURING AN EMERGENCY WITHOUT THE NEED FOR ADDITIONAL SUPPORT IN CONFORMANCE WITH #9, 7, 1, 2, 2, 8.
 - WHERE A PROTECTIVE ENCLOSURE IS INSTALLED OVER A WINDOW WELL, IT SHALL BE OPERABLE FROM THE INSIDE WITHOUT THE USE OF KEYS, TOOLS, OR SPECIAL KNOWLEDGE.
- MOISTURE PROTECTION**
- PROVIDE FLASHING BETWEEN HORIZONTAL INTERSECTIONS OF DIFFERING WALL FINISHES. ALL FLASHING TO SLOPE AWAY FROM THE BUILDING A MINIMUM OF 6%.
 - PROVIDE FLASHING AT ALL WALL-ROOF JUNCTIONS, INCLUDING PARAPETS FOR SOLID GUARDS ON DECKS.
 - BATHROOM ASSEMBLY REQUIRED FOR ALL BUILDINGS, WITH A MINIMUM CAPillary BREAK OF 3/8"
 - ALL PLATFORMS ARE ROOFS.
 - ALL ROOFS MUST SLOPE 1" IN 50 AWAY FROM WALLS, THIS INCLUDES PARAPET WALLS SURROUNDING DECKS.
 - 6" CLEARANCE REQUIRED BETWEEN DECK MEMBRANES & FLOOR.
- MISCELLANEOUS**
- LAND OR EQUAL REQUIRED TO BATHROOM FLOORS.
 - LAND OR EQUAL REQUIRED TO BATHROOM FLOORS.
 - 3/8" DRYPAL WALLBOARD REQUIRED AS TILE BAKE AROUND TUBS AND SHOWERS.
 - 3/8" DRYPAL WALLBOARD TO CEILING MEMBERS AT 2'4" O.C.
 - PROVIDE 8" CLEARANCE BETWEEN GRADE AND ROOFING.
 - DAMP-PROOFING SLABS, INCLUDING CRAWL SPACES, ARE TO BE 6 MIL "LUV" POLY.
 - FURNACE AND LAUNDRY ROOM DOORS MUST BE 2'0" MIN.
 - N.R.P. HINDER REQUIRED FOR OUTDOOR EXTERIOR DOORS.
 - FURNACE AND INTERCONNECTED SMOKE ALARMS REQUIRED ON EVERY FLOOR LEVEL DIFFERS BY 36", WITHIN 16'-4" OF BEDROOM DOORS, AND WITHIN 50'-0" OF EACH OTHER.
 - 3/8" X 3/8" X 5/8" DRY CHEMICAL FIRE EXTINGUISHER IS REQUIRED @ KITCHEN AREA.
 - HEATING AND AIR CONDITIONING EQUIPMENT MUST BE SECURED TO THE BUILDING TO RESIST OVERTURNING AND DISPLACEMENT.
 - DOORS BETWEEN GARAGE AND DWELLING ARE TO BE A SELF-CLOSING AND WEATHER-STRIPPED SOLID CORE DOOR.



1096 WEST 3RD STREET, NORTH
VANCOUVER, BC, V7P 3J6
INFO@VANCOUVERBUILDINGDESIGN.COM
778.995.3005

WWW.VANCOUVERBUILDINGDESIGN.COM

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No.	Description	Date
1	Revision 1	Date 1

NEW SFD HOUSE

534 BALLANTREE RD, WEST VANCOUVER

SITE PLAN/ ZONING ANALYSIS/ GENERAL NOTES

PROJECT NUMBER: NA

DATE: 14 APR 23

DRAWN BY: I.GOMAN


CHECKED BY: NA

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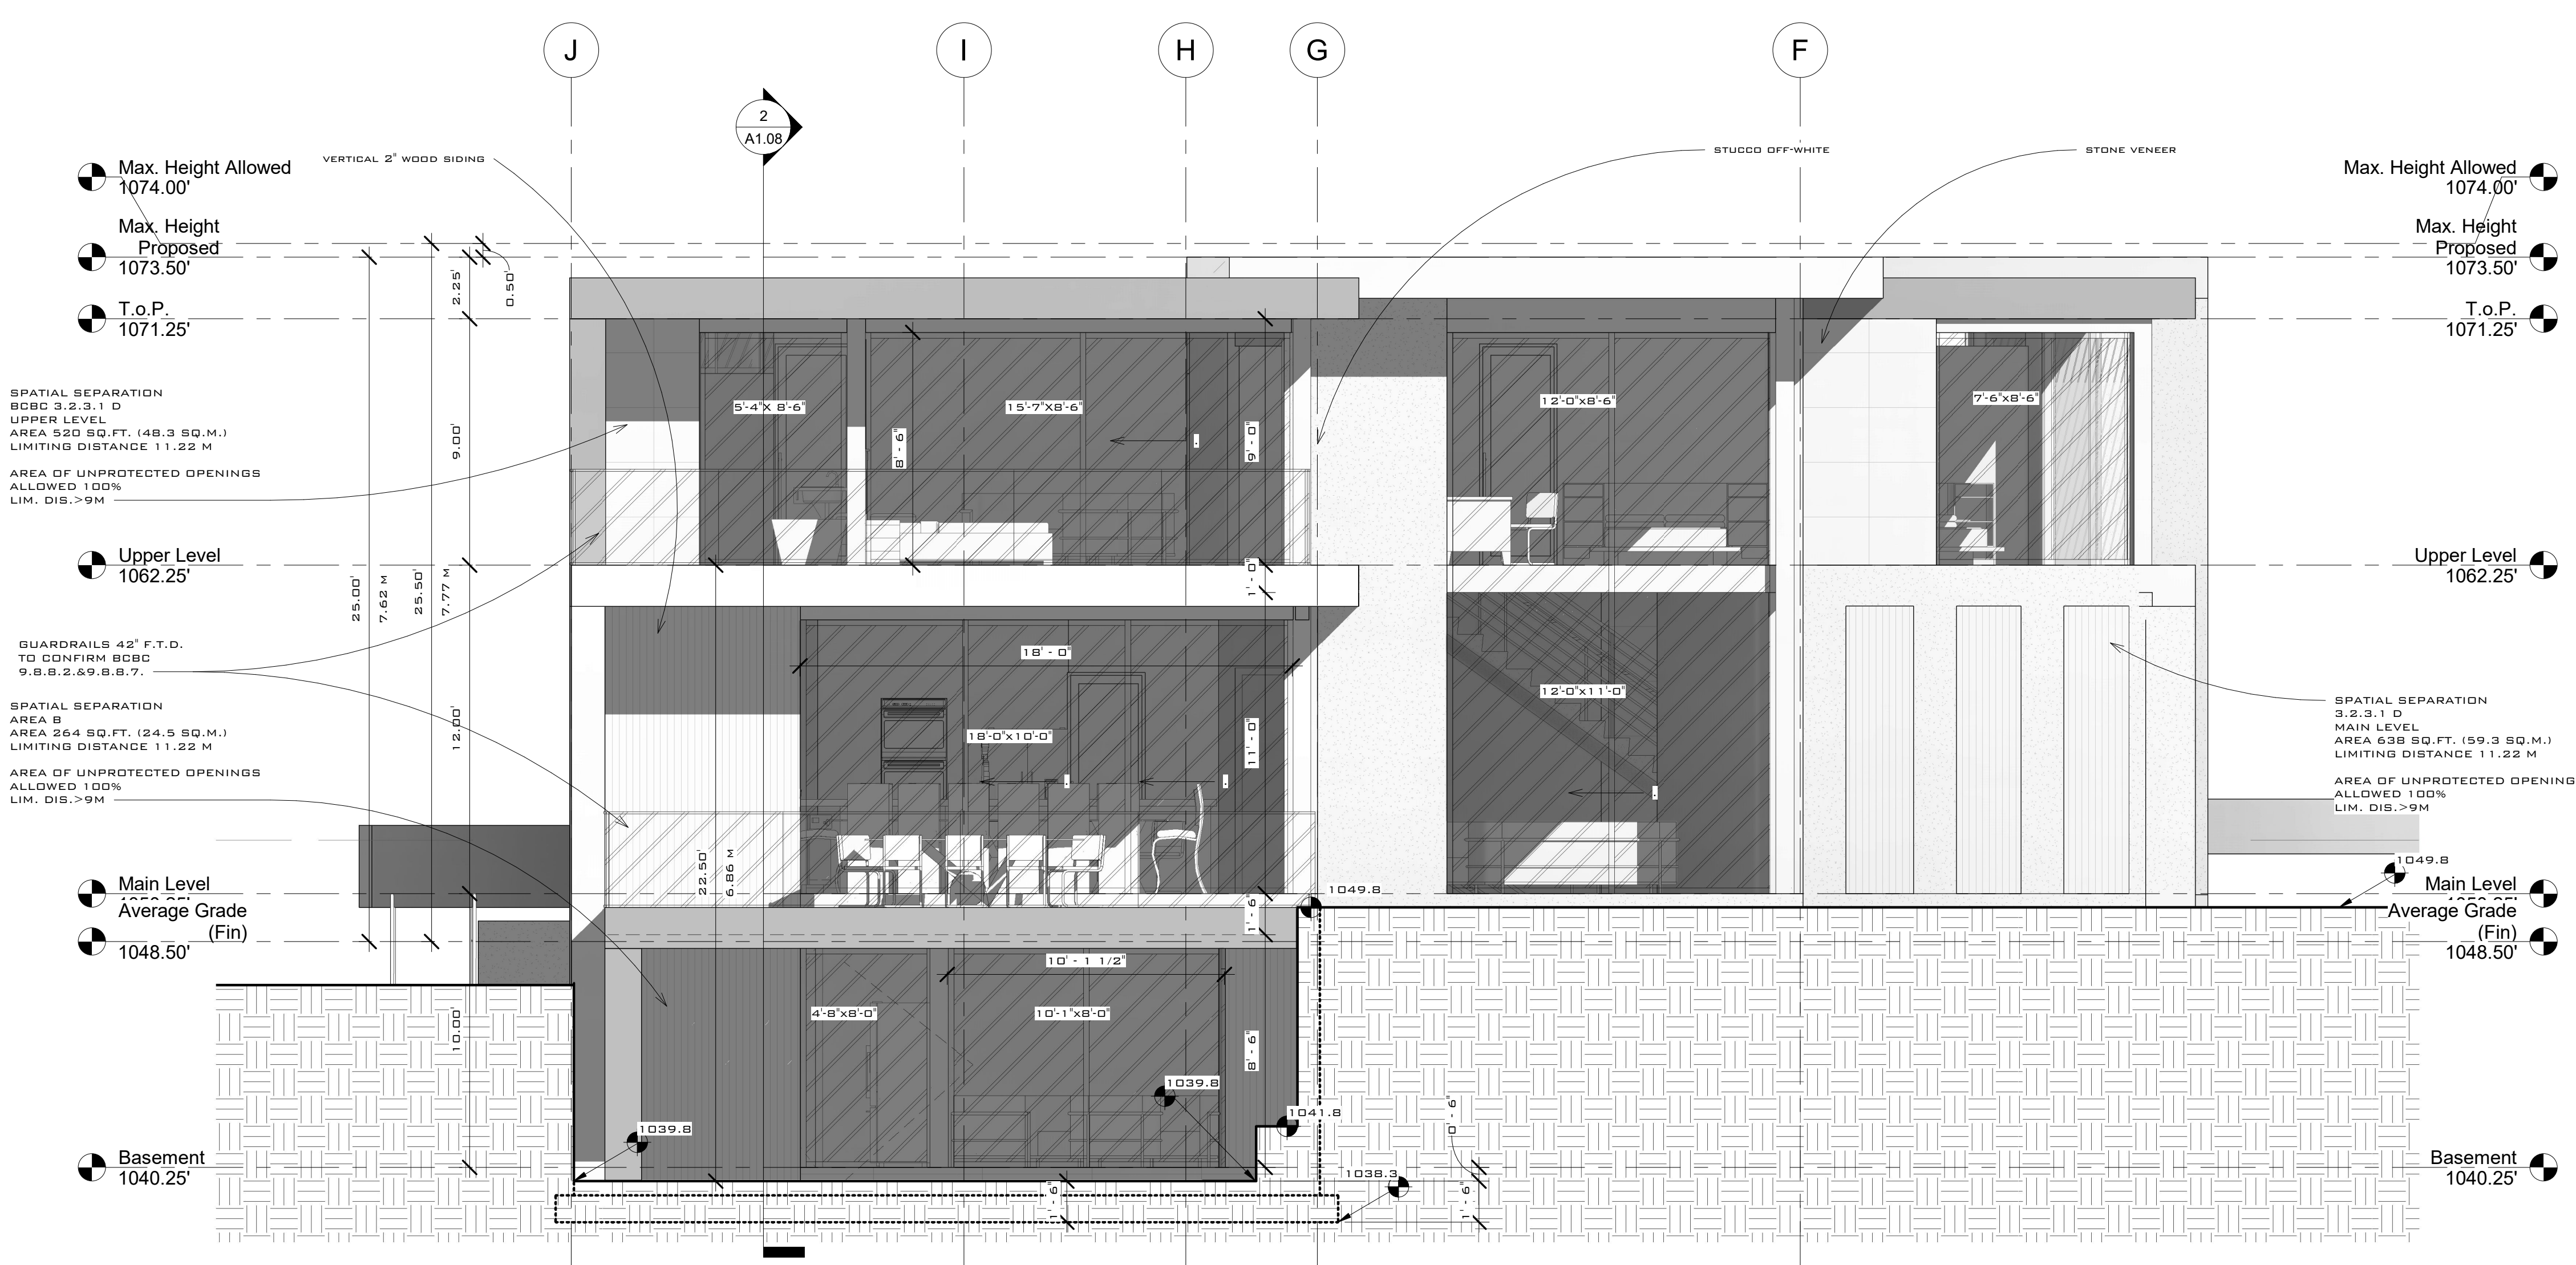
SCALE: 1/8" = 1'-0"

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1 Front NE Elevation
1/4" = 1'-0"



2 Left SE Elevation
1/4" = 1'-0"

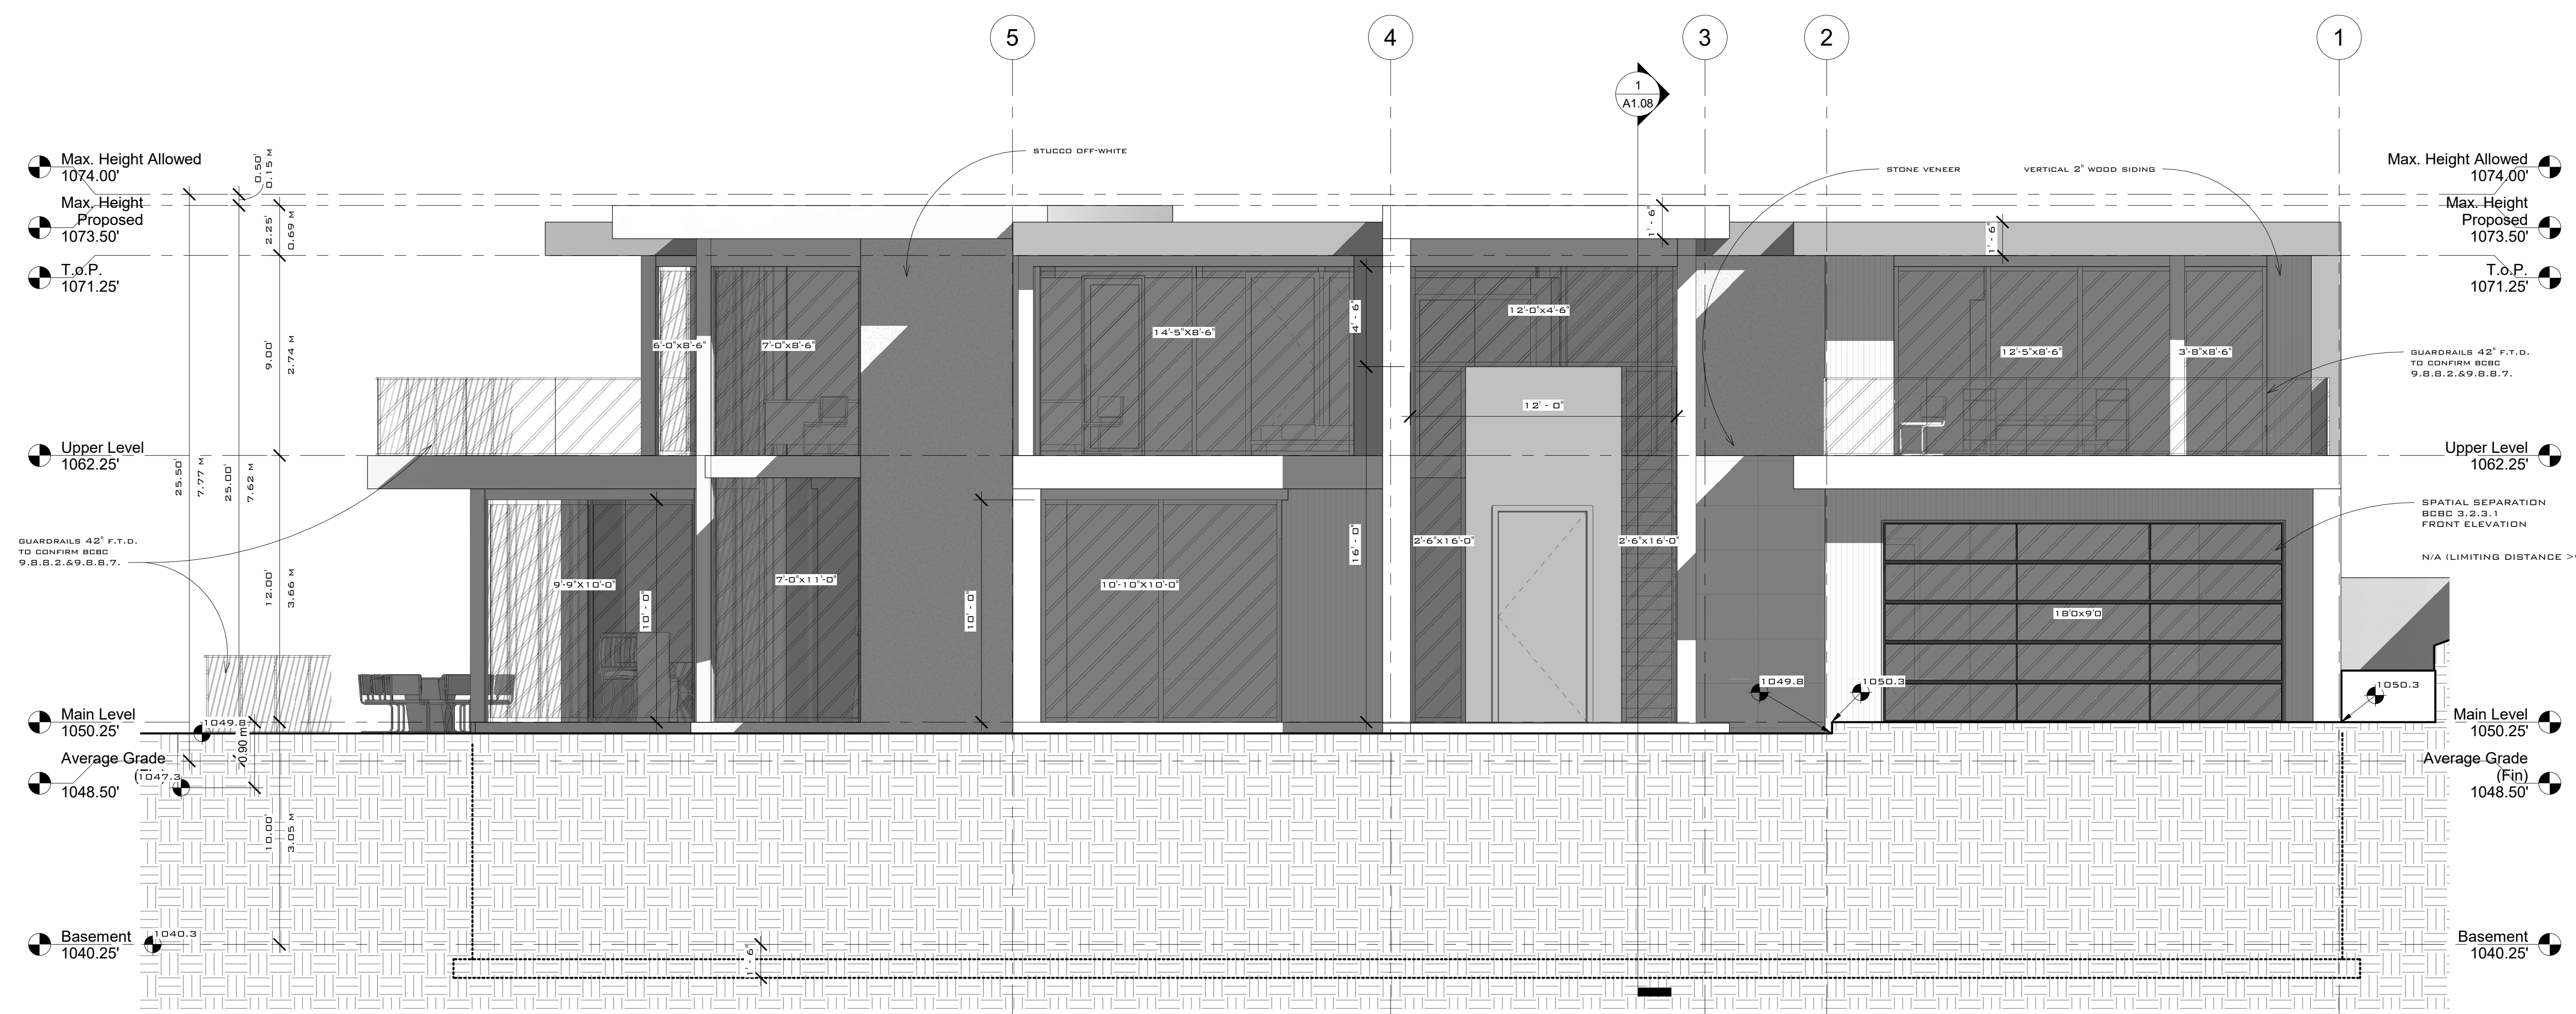No.	Description	Date

NEW SFD HOUSE

534 BALLANTREE RD, WEST VANCOUVER

FRONT & LEFT ELEVATIONS

PROJECT NUMBER NA
DATE 14 APR 23
DRAWN BY I. GOMAN
CHECKED BY NA

A1.06


SCALE 1/4" = 1'-0"

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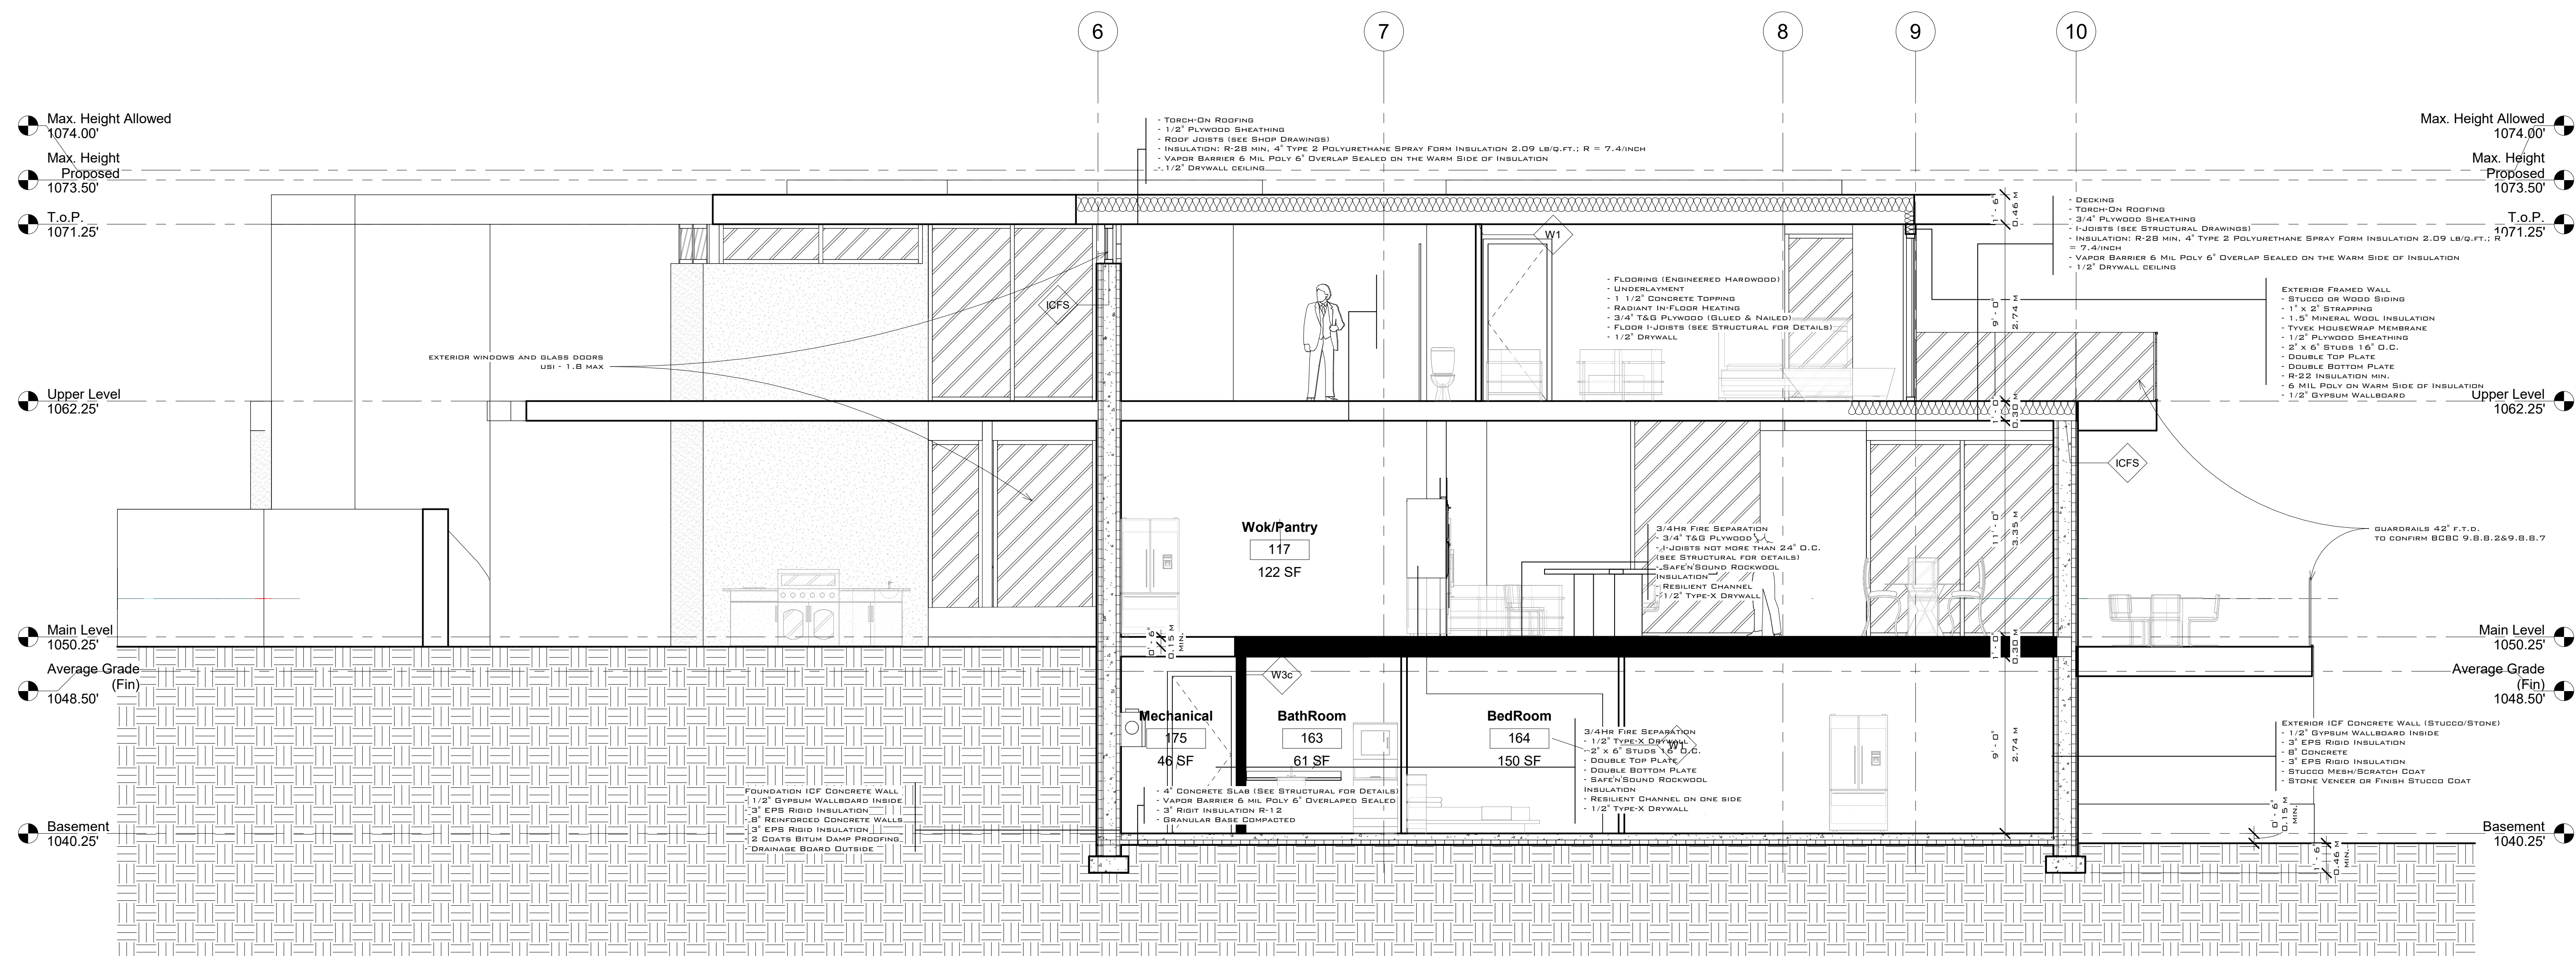
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NOTICE: FOR DESIGN LOADS, LOCATION AND DETAILS OF STRUCTURAL ELEMENTS, INCLUDING: LOAD-BEARING WALLS, SHEAR WALLS, FOOTINGS, FOUNDATION WALLS, POSTS, BEAMS, JOISTS AND LINTELS SEE STRUCTURAL SET OF DRAWINGS AND NOTES.

- ICFF1: FOUNDATION ICF WALL**
 - 1/2" GYPSUM WALLBOARD INSIDE
 - 3" EPS RIGID INSULATION
 - 8" CONCRETE
 - 3" EPS RIGID INSULATION
 - 2 COATS BITUM DAMP PROOFING
 - DRAINAGE BOARD OUTSIDE
- ICFF2: EXTERIOR ICF SIDING WALL**
 - SIDING
 - STRAPPING
 - 3" EPS RIGID INSULATION
 - 8" REINFORCED CONCRETE
 - 3" EPS RIGID INSULATION
 - 1/2" GYPSUM WALLBOARD
- ICFF3: EXTERIOR ICF MASONRY WALL**
 - STONE VENEER
 - SPRATCH COAT ON MASONRY MESH
 - 3" EPS RIGID INSULATION
 - 8" REINFORCED CONCRETE
 - 3" EPS RIGID INSULATION
 - 1/2" GYPSUM WALLBOARD
- ICFF4: EXTERIOR ICF STUCCO WALL**
 - ACRYLIC STUCCO
 - 3" EPS RIGID INSULATION
 - 8" REINFORCED CONCRETE
 - 3" EPS RIGID INSULATION
 - 1/2" GYPSUM WALLBOARD
- SW1.1: TYPICAL INTERIOR WALL 1**
 - 2" X 4" STUDS 16" O.C.
 - DOUBLE TOP PLATE
 - DOUBLE BOTTOM PLATE FOR CONCRETE TOPPING
 - 1/2" GYPSUM WALL BOARD ON EACH SIDE
- SW1.2: TYPICAL INTERIOR LOAD BEARING WALL 1**
 - 2" X 6" STUDS 16" O.C.
 - DOUBLE TOP PLATE
 - DOUBLE BOTTOM PLATE FOR CONCRETE TOPPING
 - RESILIENT CHANNEL ON ONE SIDE
 - 1/2" GYPSUM WALL BOARD ON EACH SIDE
- SW1.3: INTERIOR 3/4HR FIRE SEPARATION WALL 1**
 - 2" X 6" STUDS 16" O.C.
 - DOUBLE TOP PLATE
 - DOUBLE BOTTOM PLATE FOR CONCRETE TOPPING
 - SAFE/SOUND INSULATION
 - RESILIENT CHANNEL ON ONE SIDE
 - 1/2" TYPE-X GYPSUM WALL BOARD ON EACH SIDE



1 Section Through Stairs
1/4" = 1'-0"

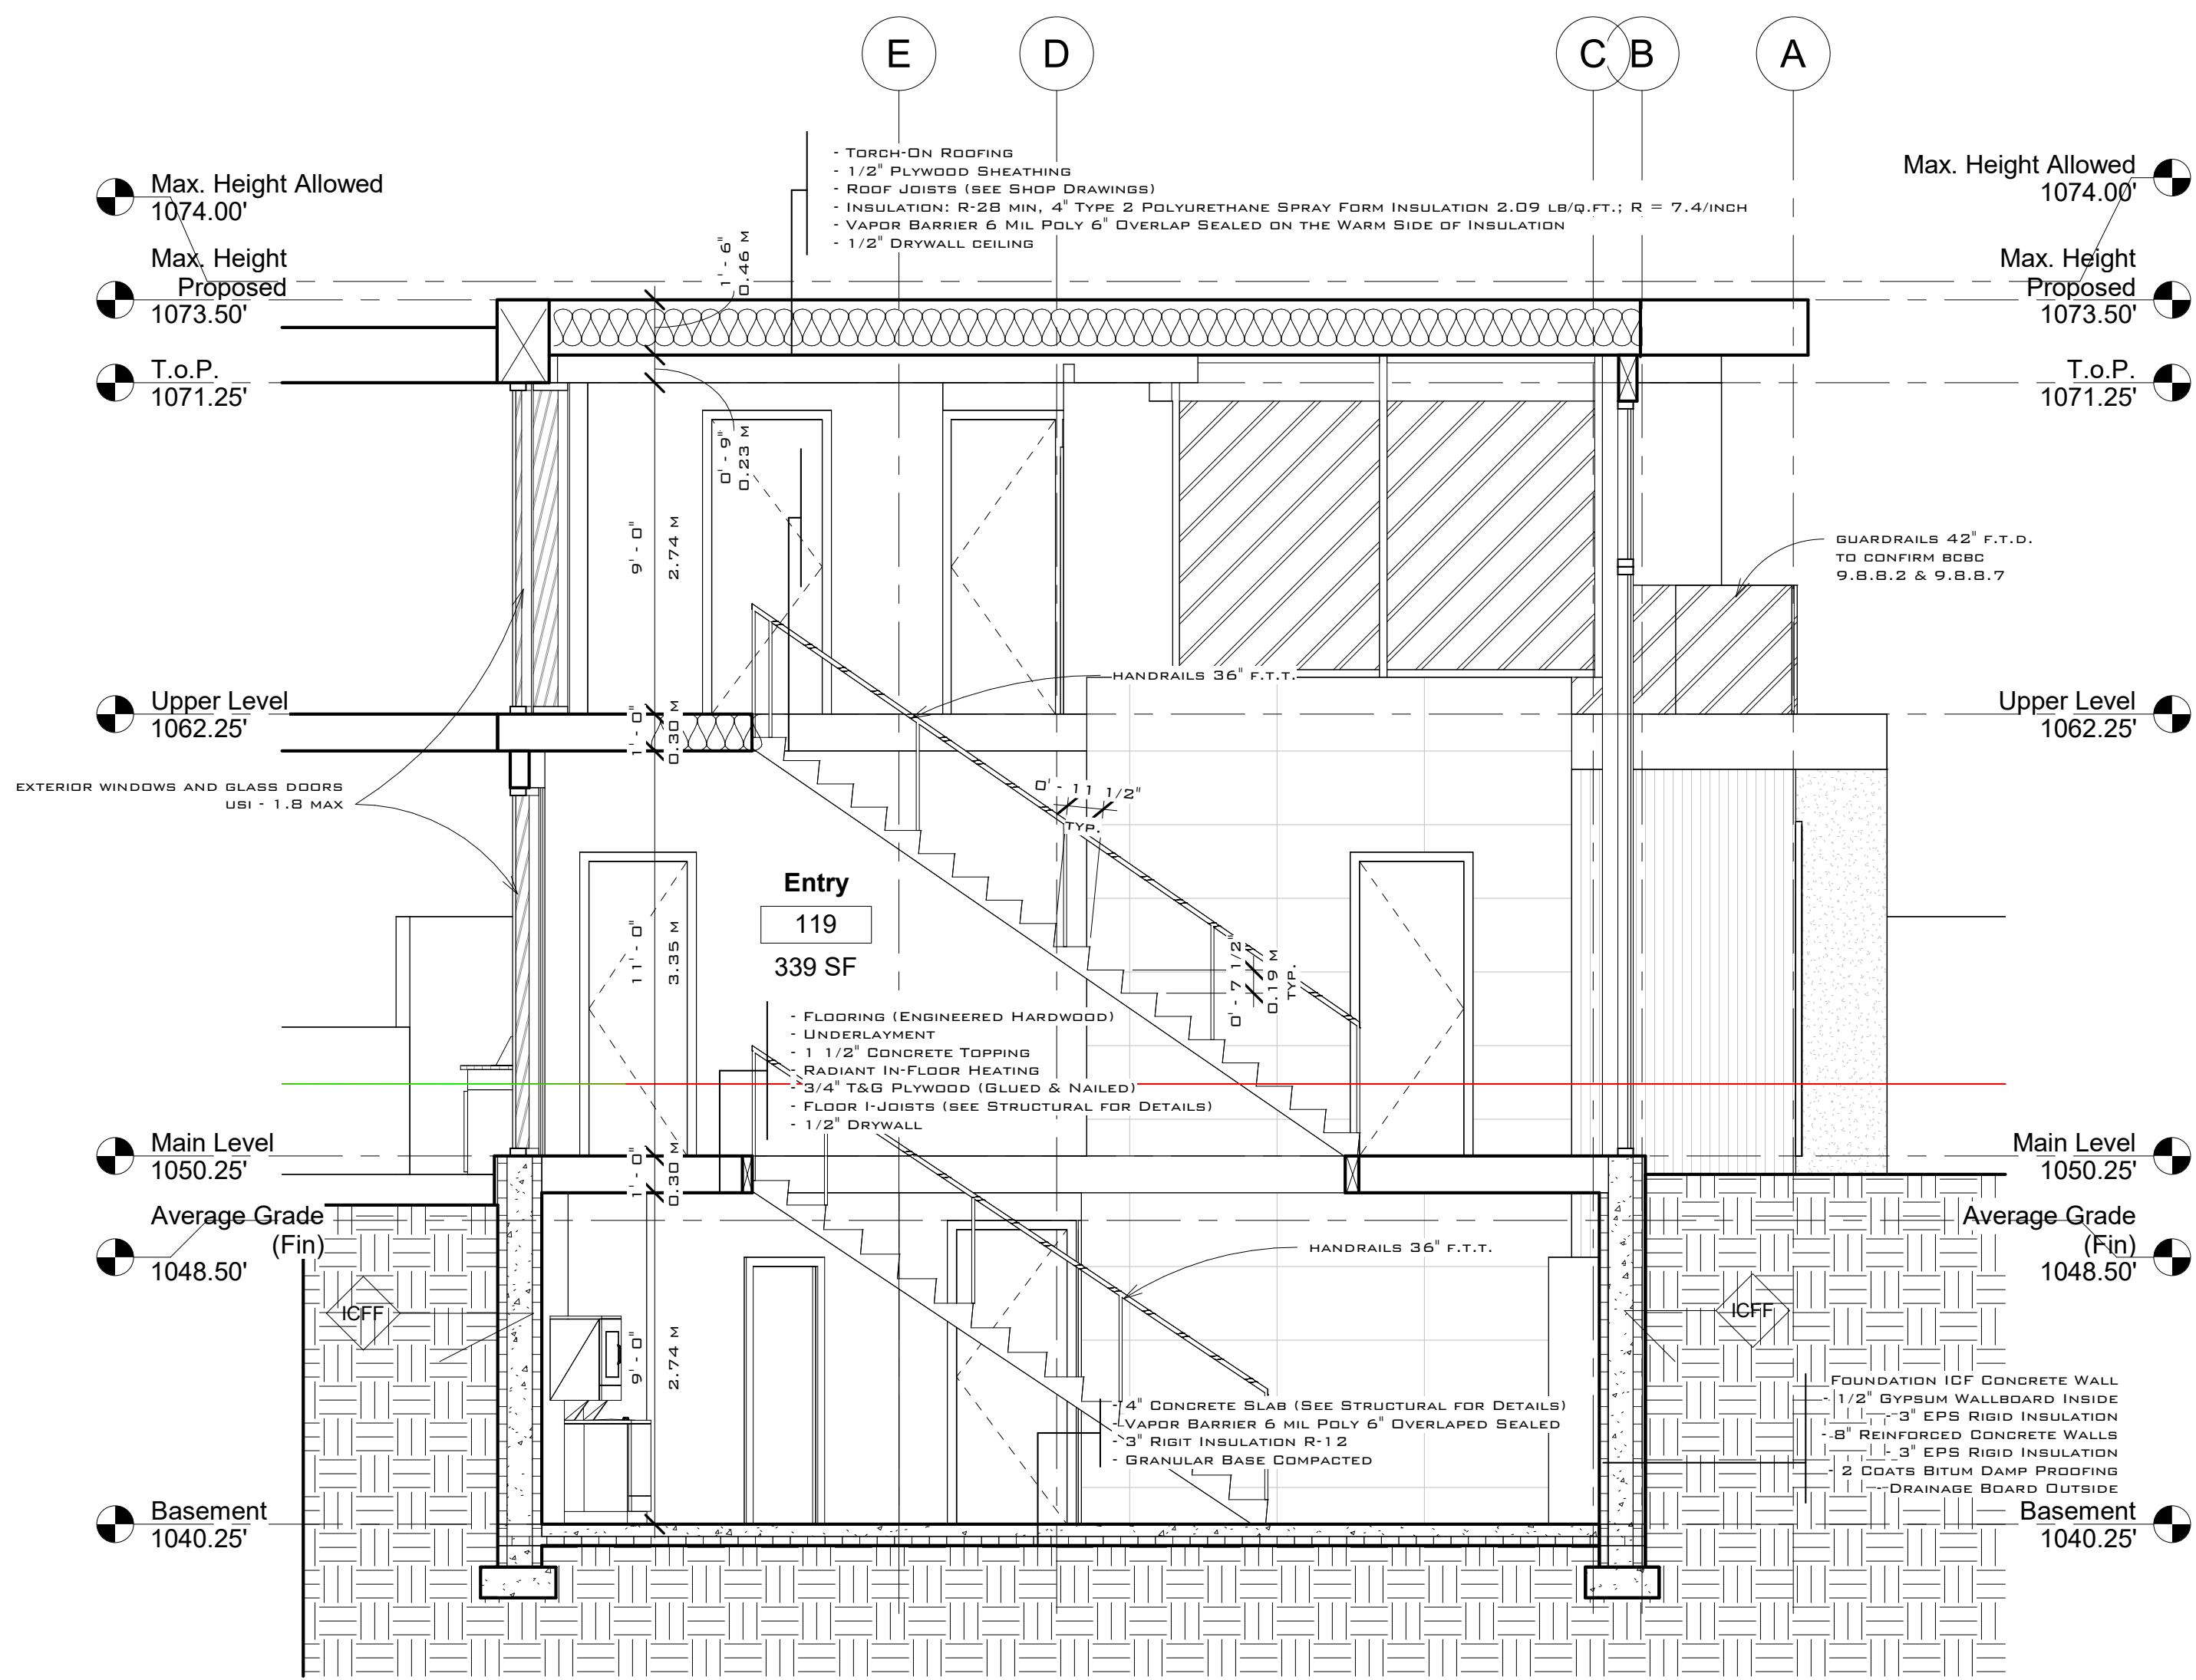

2 Building Cross-Section
1/4" = 1'-0"

No.	Description	Date

NEW SFD HOUSE

534 BALLANTREE RD, WEST
VANCOUVER

CROSS SECTIONS

PROJECT NUMBER NA
DATE 14 APR 23
DRAWN BY I.GOMAN
CHECKED BY NA

A1.08

SCALE 1/4" = 1'-0"

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⑦ 3D View Front 1



⑧ 3D View Front 3



③ 3D View Driveway



① 3D View Front 2



② 3D View Side 3



⑤ 3D View Side 2



⑥ 3D View Side 1



④ 3D View Rear

No.	Description	Date

NEW SFD HOUSE

534 BALLANTREE RD, WEST VANCOUVER

3D VIEWS

PROJECT NUMBER	NA
DATE	14 APR 23
DRAWN BY	I. GOMAN
CHECKED BY	NA

A1.09

SCALE