
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MAR 13 2019

Planning & Development Services

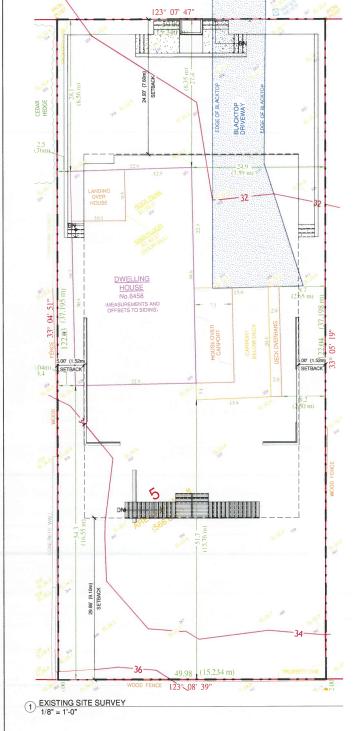

Single garage per side plus additional back yard parking per unit as required.

PROJECT DATA

WEST VANCOUVER FOLIO #; 01-0253
CIVIC: 6458 BRUCE STREET, WEST VANCOUVER, BC
PID: 014-049-228
LEGAL: LOT 5 BLOCK 36 DISTRICT LOT 430 PLAN 2103

LOT: ZONING: RD2

SITE COVERGE:
LOT AREX - 5101 st (58.8 mz)
MAX.LOT COVERAGE = 40.0%, 2.440.4 SF
ACTUAL LOT COVERAGE = 40.0%, 2.440.4 SF
ACTUAL LOT COVERAGE = 1655 st (MAIN FLOOR) + 556.9 st (COVERED PATIO) + 441 st (GARAGE) = 43.5%, 2.653.9 SF

LOOR AREA RATIC:

MAX. FLOOR AREA = 0.5 (3050.5 stl) (441 st EXCLUDED FOR PARKING)

= 2"(828 st - 697 st) stl

= (1525 * 2) stl = 3050 stl


(SEE BASEMENT EXEMPTION PLAN)

<u>BUILDING HEIGHT</u>.
SEE NORTH ELEVATION CONFIRMATION OF MEAN ROOF RIGIDE EL (SHEET A195)
MAX HEIGHT - 75 €20; (25) MAIN RESIDENCE, 3.7m ACCESSORY BUILDING
ACTUAL HEIGHT *2 STOREY @ 7.62m (25) MAIN RESIDENCE, 3.7m ACCESSORY BUILDING


ENERGY CODE ZONE 4:
ATTIC CEILLING R-40 (R51.7 a)
CATHEDRAL CEILLING R-28 (R61.4.9)
WALL (2:08@16" a.c.) CAVITY R-20 (R51.3.5)
CONTINUOIS EXTERIOR WALL INSULATION NOT REQUIRED
RLOOR OVER HEATED SPACE R-28 (R61.4.9)

REQUIRED VARIANCES

INCREASE PERINTER WALL HEIGHT EXEMPTION FROM 33% TO 62% (13.33 TO 24.67) (SEE SHEET A 105) HIGHEST BUILDING FACE ENVELOPE FROM 6 7M TO 9.2M 33.7m (363.si) FLOOR AREA EXEMPTION VARIANCE FROM BASEMENT. STITE COVERNIGE FROM 40% TO 44.5%

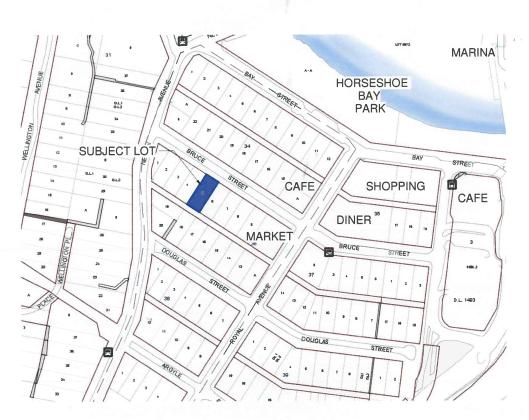

SCHEDULE A

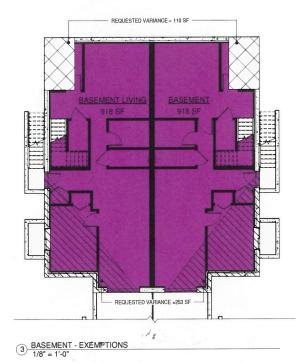

ENERGUIDE

SHOWERHEADS WILL RATEO AT LESS THAT CLITTES PER MINUTE EXHAUST FANS WILL BE "ENERGY STAP" CERTIFIED MODELS. PRE-WIRING FOR AN ELECTRIC VEHICLE CHARGING STATION WILL BE INSTALLED ON THE DISTORY OF THE NEW PARKE FERNING HAT THAN ED BY THE PROPERTY OF ATTANDED BY THE PROPERTY OF THE INSTALLATION OF OF A SOLAR PARKET HIN SYSTEM OF THE NET THAT THE THAT THE NET THAT THE NET THAT THE NET THAT THE NET THAT THE THAT THE NET THAT THE THAT THE

UPPER FLOOR (10' - 2 7/8") DRIVEWAY GARAGE LANE → 6% SLOPE AADE=35.50' MAIN FLOOR 0 - 0*

2 DRIVEWAY 1/4" = 1'-0"

#301 - 3007 GLEN DRIVE COQUITLAM, BC V3B 0L8

REVISIONS NO. DATE


DUPLEX Street, at 6458 Bruce RESIDENTIAL

title SURVEY/PROJECT DATA

s c a l e As indicated date OCT,09 2018 drawn JW checkedZE

1509 job no. sheet no. A100

consultant

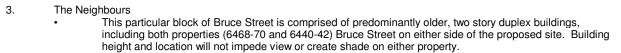

- As well, six of the nine properties on the corresponding block on Douglas Street across the back lane from this property are two story duplex homes. The commercial area of Horseshoe Bay is within half a block to the east and half a block to the north. This proximity to commercial activity and traffic makes duplex rather than single family home the logical option for
- Horseshoe Bay
 - Horseshoe Bay is home to approximately 1,000 residents. Located on the shores of Howe Sound, Horseshoe Bay features the third largest ferry terminal in the province with three births servicing the Sunshine Coast, Vancouver Island and Bowen Island. Nearly 3 million vehicles and over 7 million passengers get on or off a ferry at the Horseshoe Bay terminal every year. Sewells Marina has been in operation since 1931 and is an important destination for tourists and local
 - mariners alike offering public moorage, boat launch, boat rentals, Sea Safari expeditions and fishing A thriving business community of restaurants, cafes, and eclectic retail shops are supported by the locals
 - and prosper from the significant ferry and harbour traffic.

 Professional services including medical, dental and pharmacy allow locals to stay close to home. The small village vibe makes Horseshoe Bay a desirable neighbourhood for young families to settle. With
 - quick access to the highway, Gleneagles Community Center and a public golf course just around the corner Horseshoe Bay offers convenience to an active family. Seniors appreciate the tranquil west coast feel of Horseshoe Bay and prefer options for downsizing while remaining in the area.
- The Desirable Duplex

1 MARCH & SEPTEMBER EQUINOX 1" = 40'-0"

BRUCE STREET


Although young families would normally prefer a single family home, the benefits of space for the entire family, a yard, privacy and a mortgage helping rental suite, a duplex is often the affordable option.

Downsizing seniors are a perfect target market for duplex developers. Consolidation of space while maintaining the benefits of a single family home make a duplex a preferred option.

EDGE OF ASHPALT

- The site is a rectangular shape at 6102.06 square feet. Measuring 50 feet in width and 122.03 feet in length. The grade slopes upwards from the front of the building at 31.50ft to 36.29ft at the back. A 4.79ft increase.
- Most vegetation in the area is on other lots all around. The most "open" area would be to the north east of the lot as that is where a parking lot is located.
- Site access & building orientation The building face is to the north east. Vehicular access to the site will be from Bruce street on the north face of the lot as well as from the lane on the south face where the garage rests. Pedestrian access will also be from the north face
- Natural light and Shadow study (Refer to images for shadow diagrams)
 - The property enjoys sun on the south side most year round although there are many trees in the surrounding area that may block out the sunlight from reaching the building. As the year progresses the shadows cast from neighboring building gradulay move west covering more of the building. This building will cast shadows on neighboring buildings to the north west. The majority of theses shadows will affect the sites own front yard.
- Because of the surrounding vegetation the veiws from the building may be obstructed but the roof top balconie will help to decrease the amount not seen. To the north east of the lot is the Salish sea which connects into the Pacific ocean.



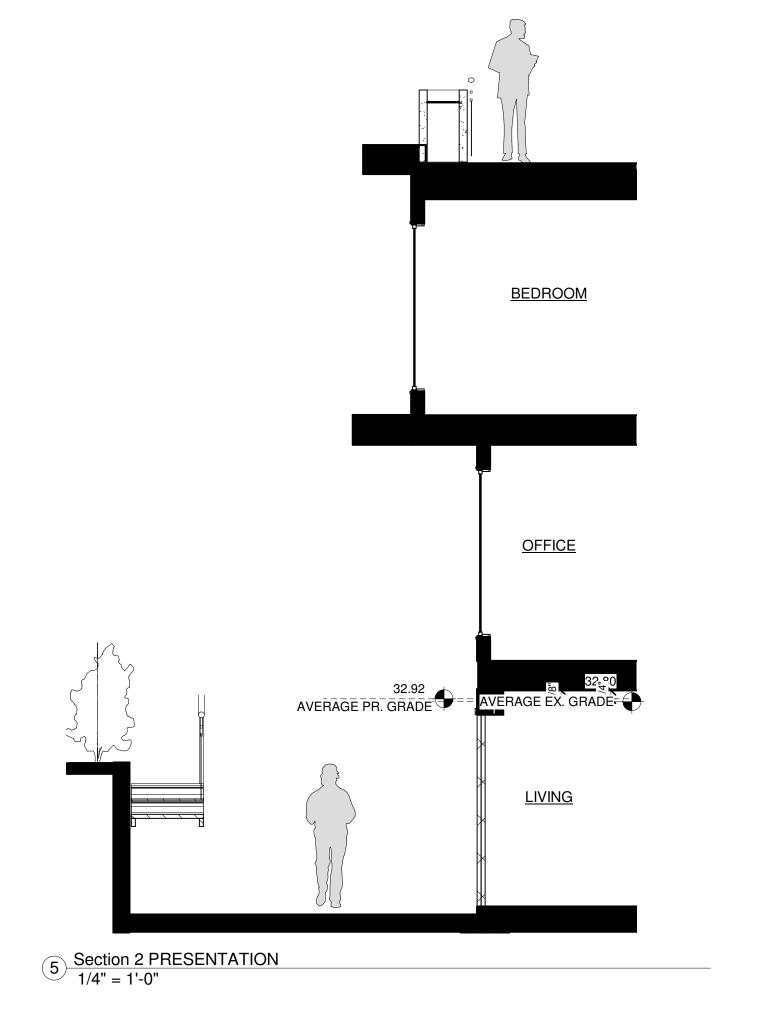





Building Massing
Facing north this modern style building is divided equally into two dwelling units on the north east and south west sides. Each dwelling unit has 3 storeys as well as a roof top balcony. The interior floor plans of the two units are mirrors of eachother.

The footprint of the building follows the rectangular property lines. The building is set back enough as to give some yard room at the front of the building as well as space in the back for a separate car

Each floor level of the house is about the same size as the others. The majority of the windows for this building are on the north and south faces to allow to flow through the units. Transom windows and sloped glazing allow for natural light & passive air flow on the building sides.

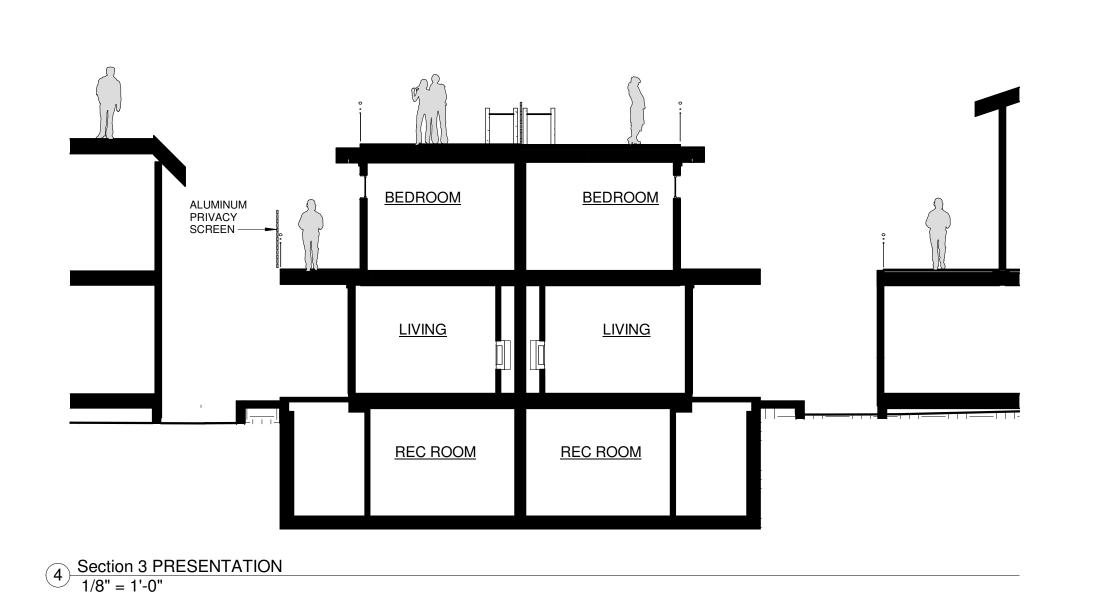

6 Section 4 PRESENTATION 1/8" = 1'-0"

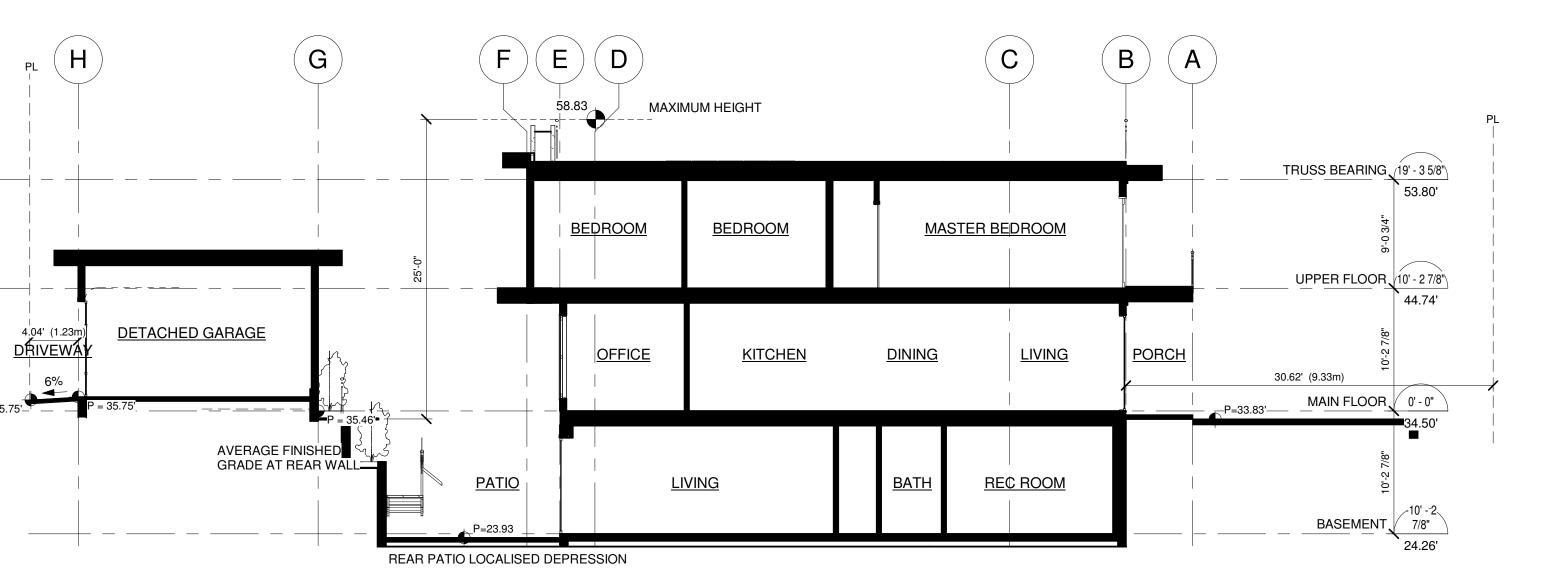

J

REVISIONS

DESCRIPTION

NO. DATE

title **BUILDING STUDY**

scale As indicated

date OCT,09 2018 drawn JW checkedZE

consultant

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6458 BRUCE ST.









#301 - 3007 GLEN DRIVE COQUITLAM, BC V3B 0L8 zane@zedstudio.com

REVISIONS

DATE DESCRIPTION

3458 Bruce Street, st Vancouver, BC

title BUILDING VIEWS

scale

d a t e OCT,09 2018

drawn TL checkedZE

job no.

sheet no. A100b


consultant

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2:05:28 PM





GENERAL NOTES:

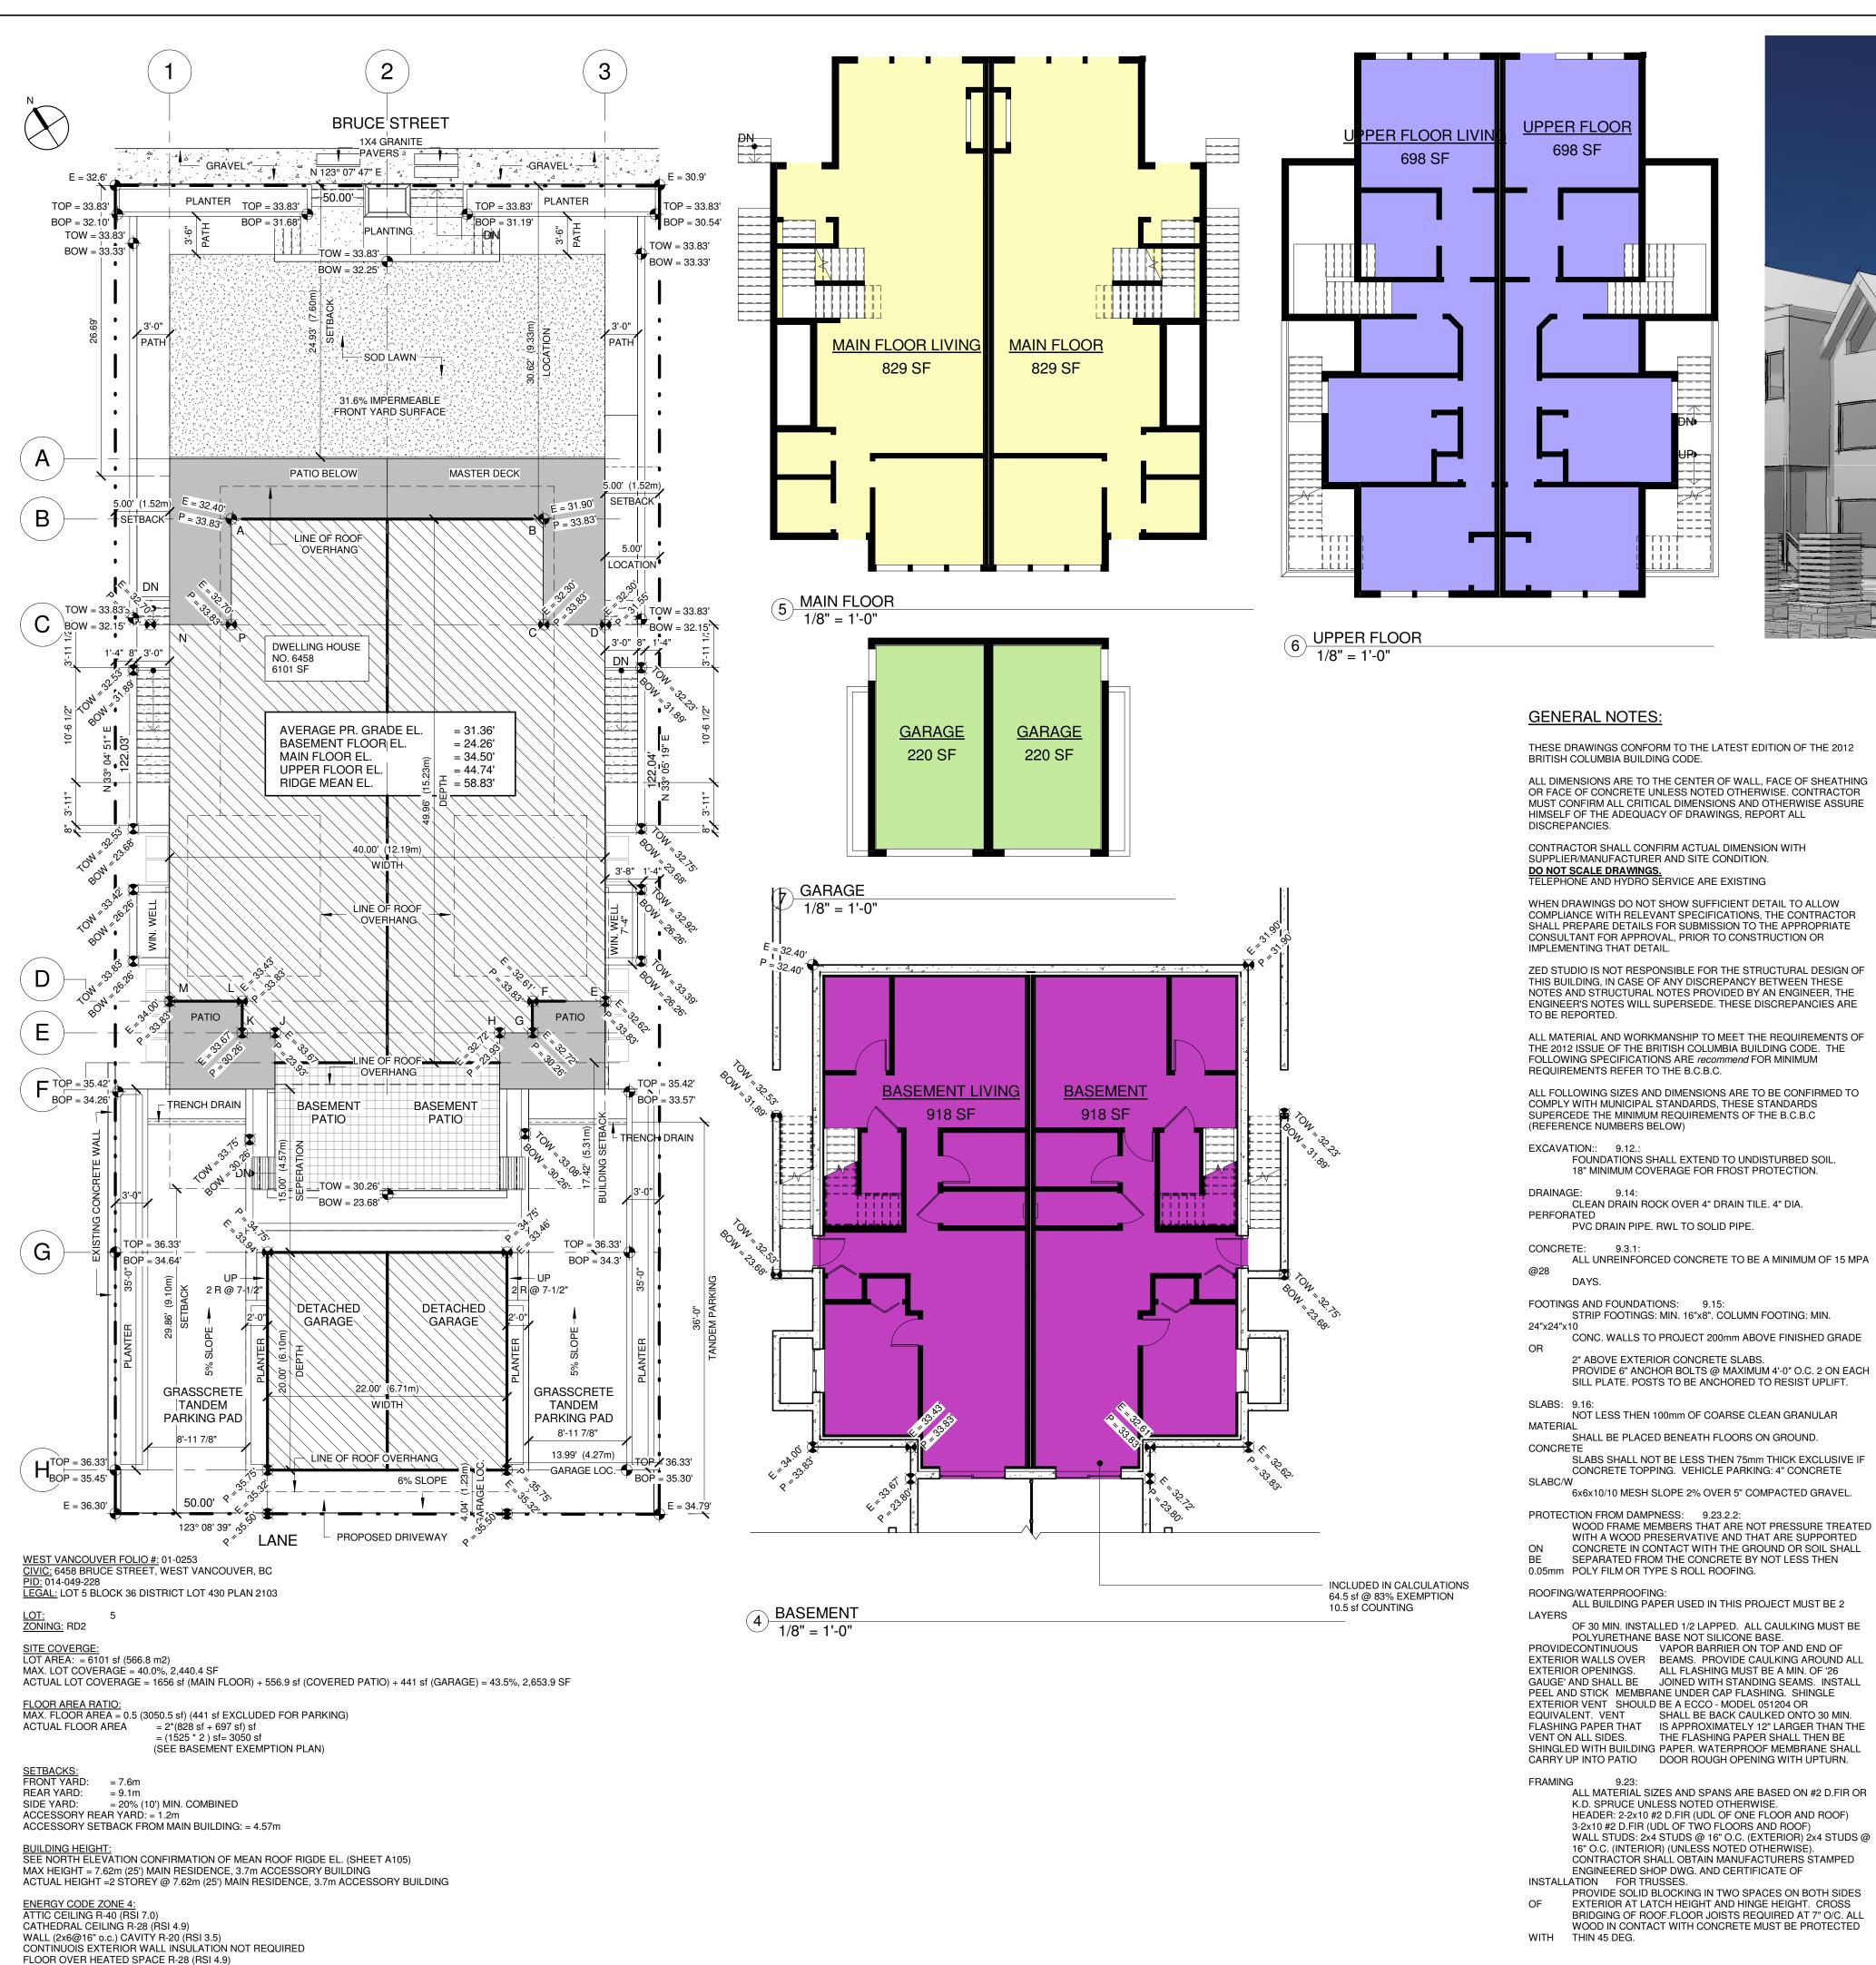THESE DRAWINGS CONFORM TO THE LATEST EDITION OF THE 2012 BRITISH COLUMBIA BUILDING CODE.

ALL DIMENSIONS ARE TO THE CENTER OF WALL, FACE OF SHEATHING OR FACE OF CONCRETE UNLESS NOTED OTHERWISE. CONTRACTOR MUST CONFIRM ALL CRITICAL DIMENSIONS AND OTHERWISE ASSURE HIMSELF OF THE ADEQUACY OF DRAWINGS, REPORT ALL DISCREPANCIES.

CONTRACTOR SHALL CONFIRM ACTUAL DIMENSION WITH SUPPLIER/MANUFACTURER AND SITE CONDITION. <u>DO NOT SCALE DRAWINGS.</u> TELEPHONE AND HYDRO SERVICE ARE EXISTING

WHEN DRAWINGS DO NOT SHOW SUFFICIENT DETAIL TO ALLOW COMPLIANCE WITH RELEVANT SPECIFICATIONS, THE CONTRACTOR SHALL PREPARE DETAILS FOR SUBMISSION TO THE APPROPRIATE CONSULTANT FOR APPROVAL, PRIOR TO CONSTRUCTION OR IMPLEMENTING THAT DETAIL.

ZED STUDIO IS NOT RESPONSIBLE FOR THE STRUCTURAL DESIGN OF THIS BUILDING, IN CASE OF ANY DISCREPANCY BETWEEN THESE NOTES AND STRUCTURAL NOTES PROVIDED BY AN ENGINEER, THE ENGINEER'S NOTES WILL SUPERSEDE. THESE DISCREPANCIES ARE

FOLLOWING SPECIFICATIONS ARE recommend FOR MINIMUM REQUIREMENTS REFER TO THE B.C.B.C. ALL FOLLOWING SIZES AND DIMENSIONS ARE TO BE CONFIRMED TO

COMPLY WITH MUNICIPAL STANDARDS, THESE STANDARDS SUPERCEDE THE MINIMUM REQUIREMENTS OF THE B.C.B.C (REFERENCE NUMBERS BELOW)

FOUNDATIONS SHALL EXTEND TO UNDISTURBED SOIL. 18" MINIMUM COVERAGE FOR FROST PROTECTION.

CLEAN DRAIN ROCK OVER 4" DRAIN TILE. 4" DIA. PVC DRAIN PIPE. RWL TO SOLID PIPE.

ALL UNREINFORCED CONCRETE TO BE A MINIMUM OF 15 MPA

FOOTINGS AND FOUNDATIONS: 9.15: STRIP FOOTINGS: MIN. 16"x8". COLUMN FOOTING: MIN. CONC. WALLS TO PROJECT 200mm ABOVE FINISHED GRADE

> PROVIDE 6" ANCHOR BOLTS @ MAXIMUM 4'-0" O.C. 2 ON EACH SILL PLATE. POSTS TO BE ANCHORED TO RESIST UPLIFT.

NOT LESS THEN 100mm OF COARSE CLEAN GRANULAR SHALL BE PLACED BENEATH FLOORS ON GROUND.

CONCRETE TOPPING. VEHICLE PARKING: 4" CONCRETE 6x6x10/10 MESH SLOPE 2% OVER 5" COMPACTED GRAVEL.

WITH A WOOD PRESERVATIVE AND THAT ARE SUPPORTED CONCRETE IN CONTACT WITH THE GROUND OR SOIL SHALL SEPARATED FROM THE CONCRETE BY NOT LESS THEN 0.05mm POLY FILM OR TYPE S ROLL ROOFING.

ROOFING/WATERPROOFING: ALL BUILDING PAPER USED IN THIS PROJECT MUST BE 2

OF 30 MIN. INSTALLED 1/2 LAPPED. ALL CAULKING MUST BE POLYURETHANE BASE NOT SILICONE BASE. PROVIDECONTINUOUS VAPOR BARRIER ON TOP AND END OF EXTERIOR WALLS OVER BEAMS. PROVIDE CAULKING AROUND ALL EXTERIOR OPENINGS. ALL FLASHING MUST BE A MIN. OF '26 GAUGE' AND SHALL BE JOINED WITH STANDING SEAMS. INSTALL PEEL AND STICK MEMBRANE UNDER CAP FLASHING. SHINGLE EXTERIOR VENT SHOULD BE A ECCO - MODEL 051204 OR EQUIVALENT. VENT SHALL BE BACK CAULKED ONTO 30 MIN. FLASHING PAPER THAT IS APPROXIMATELY 12" LARGER THAN THE VENT ON ALL SIDES. THE FLASHING PAPER SHALL THEN BE SHINGLED WITH BUILDING PAPER. WATERPROOF MEMBRANE SHALL CARRY UP INTO PATIO DOOR ROUGH OPENING WITH UPTURN.

ALL MATERIAL SIZES AND SPANS ARE BASED ON #2 D.FIR OR K.D. SPRUCE UNLESS NOTED OTHERWISE. HEADER: 2-2x10 #2 D.FIR (UDL OF ONE FLOOR AND ROOF) 3-2x10 #2 D.FIR (UDL OF TWO FLOORS AND ROOF) WALL STUDS: 2x4 STUDS @ 16" O.C. (EXTERIOR) 2x4 STUDS @ 16" O.C. (INTERIOR) (UNLESS NOTED OTHERWISE). CONTRACTOR SHALL OBTAIN MANUFACTURERS STAMPED ENGINEERED SHOP DWG. AND CERTIFICATE OF

INSTALLATION FOR TRUSSES. PROVIDE SOLID BLOCKING IN TWO SPACES ON BOTH SIDES EXTERIOR AT LATCH HEIGHT AND HINGE HEIGHT. CROSS BRIDGING OF ROOF.FLOOR JOISTS REQUIRED AT 7" O/C. ALL WOOD IN CONTACT WITH CONCRETE MUST BE PROTECTED

WATER RESISTANT FLOORING REQUIRED IN ENTRY, LAUNDRY. KITCHEN, MECHANICAL RM. AND BATHROOMS. PROVIDE 2/8" PLY. UNDER.

R20 INSULATION AND6 MIL. POLY V.B. BETWEEN HEATED AND UNHEATED SPACE, THE EXTERIOR AIR OR THE EXTERIOR

ATTICS: CROSS VENT ROOF 1/150TH OF AREA OR ATTIC SPACE 1/300TH OF AREA WITH A MINIMUM OF 25% AT THE TOP AND 25% AT THE BOTTOM, INSTALL INSULATION STOPS AS REQUIRED. PROVIDE MIN 20"x28" ACCESS WITH TIGHT FITTING INSULATED COVER.

FIREPLACE: 9.22.: PROVIDE MINIMUM 4" COMBUSTION AIR DUCT FROM FOR WOOD BURNING FIREPLACE PROVIDE MINIMUM 16" NON- COMBUSTABLE HEARTH AND CO2 DETECTOR. ALL MANUFACTURED FIREPLACE AND FLUES TO CONFORM TO CAN/ULC S610 STANDARD. INSTALL TO MANUFACTURER'S SPECIFICATIONS AND U.L.C. LISTING REQUIREMENT. INSTALL

WONDERBOARD UNDER NON COMBUSTIBLE HEARTH FINISH.

DRAWINGS TO BE PROVIDED WITH AT LEAST ONE VENT NOT

LESS THAN 3" IN SIZE AND SHALL TERMINATE THROUGH THE

PLUMBING TO MEET REQUIREMENTS OF THE 2012 B.C.B.C. INCLUDING 7.5.5.5: EVERY STORY IN WHICH PLUMBING IS OR BE INSTALLED. INCLUDING THE BASEMENT OF A SINGLE FAMILY DWELLING, SHALL HAVE EXTENDED INTO IT OR PASSING THROUGH IT A VENT PIPE THAT IS AT LEAST 1 1/2" IN SIZE THE PROVISION OF FUTURE CONNECTIONS, ALL BUILDING

WATERPROOF WALL BOARD REQUIRED AROUND TUB AND

WHERE NATURAL VENTILATION OF ROOMS DOES NOT MEET REQUIREMENTS OF TABLE 9.32.2.2 MECHANICAL VENTILATION IS REQUIRED: NOT MECHANICALLY COOLED: PROVIDE 1 AIR CHANGE PER HOUR. MECHANICALLY COOLED: PROVIDE 1/2 CHANGE PER HOUR.

HEATING HEATING SYSTEM TO MEET REQUIREMENTS OF 2012 B.C.B.C.

SAFETY OR WIRED GLASS IS REQUIRED WHERE GLASS CAN MISTAKEN FOR A DOOR OPENING AND WITHIN 36" OF DOOR LOCKS OR 8" OF FLOOR. DOORS BETWEEN GARAGE AND DWELLING TO BE SELF CLOSING AND WEATHER STRIPPED ENTRANCE AND EXTERIOR DOORS TO DWELLING UNITS TO COMPLY WITH B.C.B.C. 9.6.4 & 9.6.6. DOORS TO BATHROOMS AND ALL ENSUITE DOORS TO UNDERCUT 1/2" FOR SUITE VENTILATION.

SECURITY ALL EXTERIOR DOORS TO MEET THE REQUIREMENTS OF 9.6.8

BEDROOM WINDOWS TO HAVE A MIN. UNOBSTRUCTED

OF NOT LESS THAN 0.35M2 AND NO DIMENSION LESS THAN 0.38m. OPENING MUST BE MAINTAINED DURING AN EMERGENCY WITHOUT THE NEED FOR ADDITIONAL SUPPORT. FRAMES ARE TO BE THERMALLY BROKEN. ALL DIMENSIONS ARE NOMINAL, SITE MEASURE AS REQUIRED. ALL FRAMES TO HAVE NAILING FLANGE AND TO BE PLACED DIRECTLY ON WINDOW SILL. WINDOW LOCATED WITHIN 3'-0" DOOR LOCKS REQUIRED TO HAVE SAFETY OR WIRED GLASS CONFORMING TO 3.31.18(2). WINDOWS TO CONFORM TO SECTION 3.7.2 AND SUBSECTION 9.7 NATIONAL BUILDING CODE AND TO BE MANUFACTURED IN ACCORDANCE WITH A3.B3.C3 CSA AA440-M98 PERFORMANCE TEST. PROVIDE MOCK UP WINDOW ASSEMBLY FOR TESTING. MIRRORED DOORS AND BIFOLDS TO CONFORM TO BCBC 9.6.6.3. ALL GLAZING 8" OR

LOWER A.F.F. TO BE SAFETY GLASS. GLAZING AT ENTRANCE DOORS, SHOWER DOORS, TUBS AND SLIDING DOORS TO CONFORM TO 9.6.6 WINDOWS OVER STAIRS AND LANDINGS CONFORM TO 9.7.5.3. WINDOWS THAT EXTEND TO LESS 900mm ABOVE THE LANDING SHALL BE PROTECTED WITH GUARDS (9.8.8.) OR NON-OPENABLE AND DESIGNED TO WITHSTAND THE SPECIFIED LATERAL LOADS FOR BALCONY GUARDS (4.1.5.15.)

SAFETY GLASS MUST BE USED WHEN ENCLOSING BATHTUBS SHOWERS. ALL DOORS AND WINDOWS TO BE DOUBLE

FLASH ALL EXT. WALL OPENINGS WHERE THE VERTICAL FROM THE BOTTOM OF THE EAVE TO THE TOP OF MORE THAN 1/4 OF THE EAVE OVERHANG. THE TRIM IS STAIRS 9.8:

SEE SECTION FOR STAIR SPECIFICATIONS.

GUARDRAILS REQUIRED WHERE FLOOR TO FLOOR OR FLOOR (DECK, LANDING ETC.) TO GRADE EXCEEDS 24". NO OPENING GREATER THAN 4". NO MEMBERS LOCATED BETWEEN 4"-36" ABOVE FLOOR OR DECK ETC. THAT WILL FACILITATE

INTERIOR GUARDRAILS: MIN. 36" EXTERIOR GUARDRAILS: MIN. 42" EXCEPT WHERE DECK TO GRADE IS LESS THAN 6'-0". THAN EXTERIOR GUARDRAILS: 36" HANDRAILS FOR STAIRS: 32" ABOVE nosing

GUARDRAILS FOR STAIRS: 36" ABOVE NOSING. GUARDRAILS TO BE DESIGNED FOR 1.5 KN/M HORIZONTAL VERTICAL LOAD AT TOP OF RAIL PLUS I.O. KP PANEL LOADS, NO OPENING MORE THAN 4"

SMOKE ALARMS: 9.10.19: SMOKE ALARMS TO CONFORM TO CAN/ULC-S531. AT LEAST SMOKE ALARM ON EACH FLOOR, INCLUDING BASEMENTS. SMOKE ALARM TO WITHIN 5M OF ALL BEDROOM DOORS AND

15M OF ANY POINT THE SAME FLOOR, MEASURED FOLLOWING CORRIDORS. SMOKE ALARMS TO BE INSTALLED BY PERMANENT CONNECTION TO AN ELECTRICAL CIRCUIT. ALL SMOKE ALARMS TO BE INTERCONNECTED.

CO ALARMS: 9.32.4.2 CARBON MONOXIDE ALARMS TO CONFORM TO CSA 6.19. CARBON MONOXIDE ALARMS TO BE INSTALLED BY CONNECTION TO AN ELECTRICAL CIRCUIT. CARBON ALARM TO BE INSTALLED WITHIN 5M OF ALL MONOXIDE DOORS, MEASURED FOLLOWING CORRIDORS. BEDROOM

MISCELLANEOUS: PROVIDE MIRRORS BEHIND ALL BATHROOM SINKS. REVISIONS DESCRIPTION NO. DATE

6 DEC 12, 2016 ISSUED FOR PERMITS

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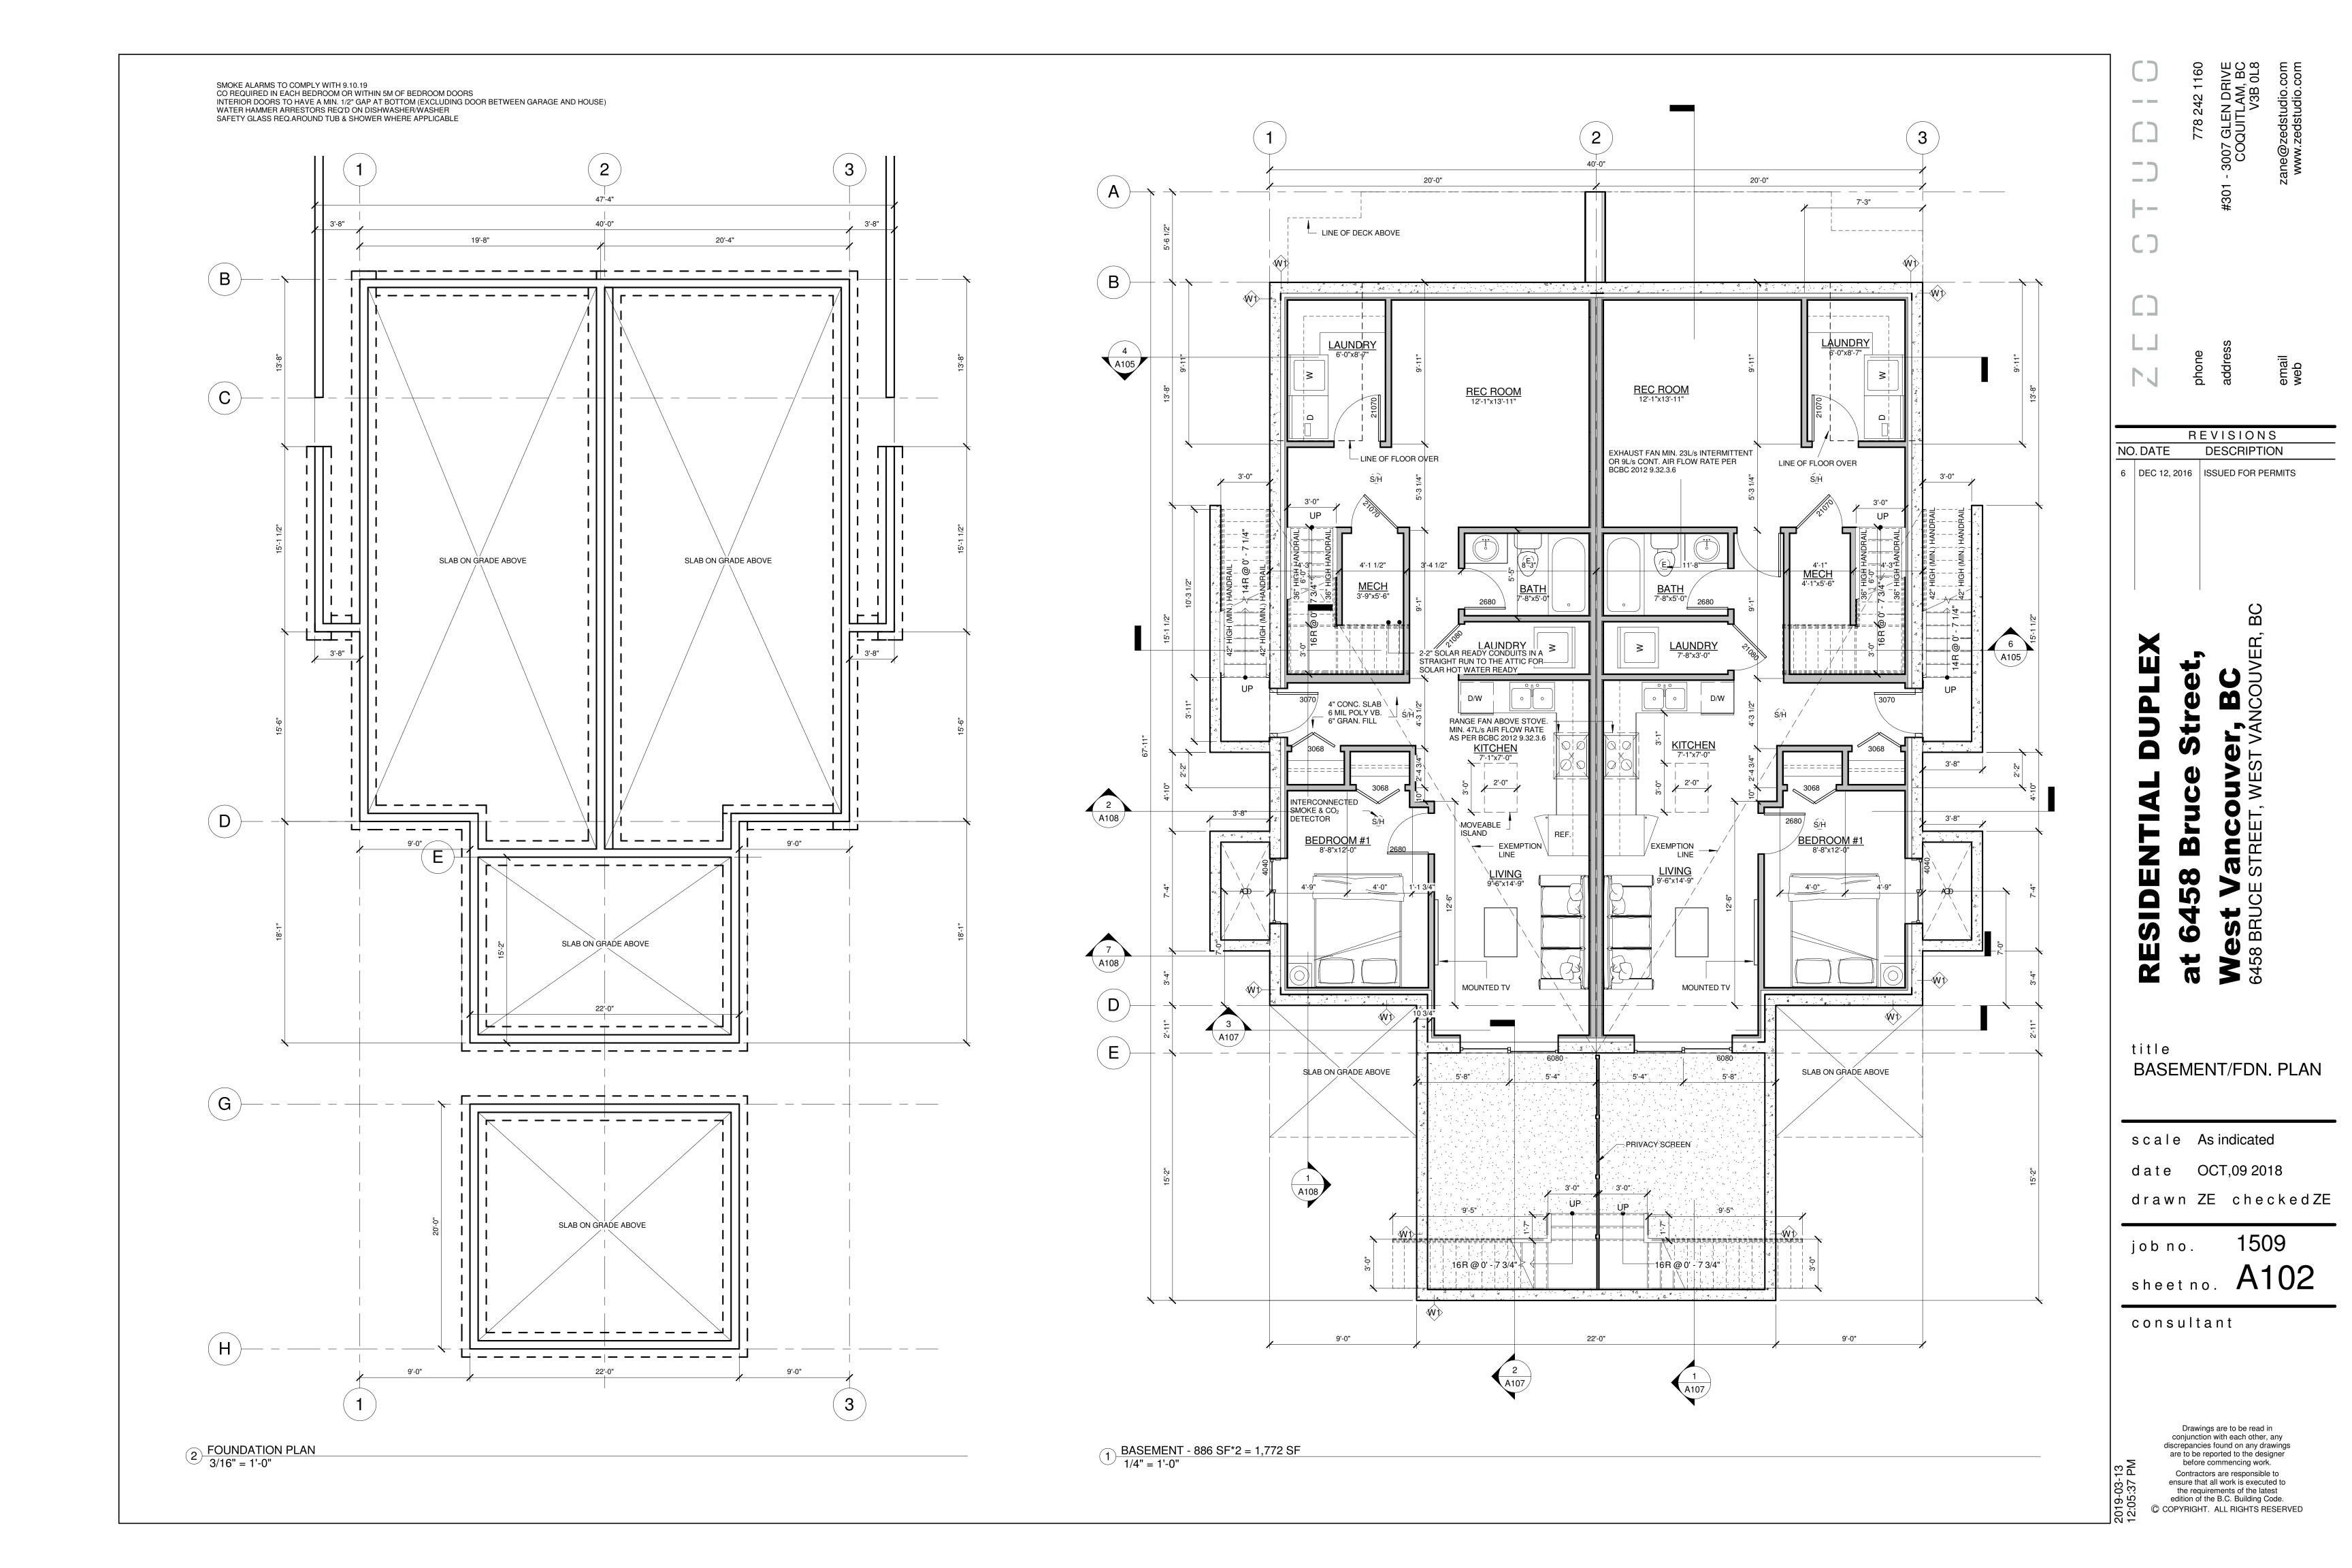
title SITE PLAN


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6 DEC 12, 2016 ISSUED FOR PERMITS

title MAIN/UPPER FLOOR PLAN

scale 1/4'' = 1'-0''


date OCT,09 2018 drawn ZE checkedZE


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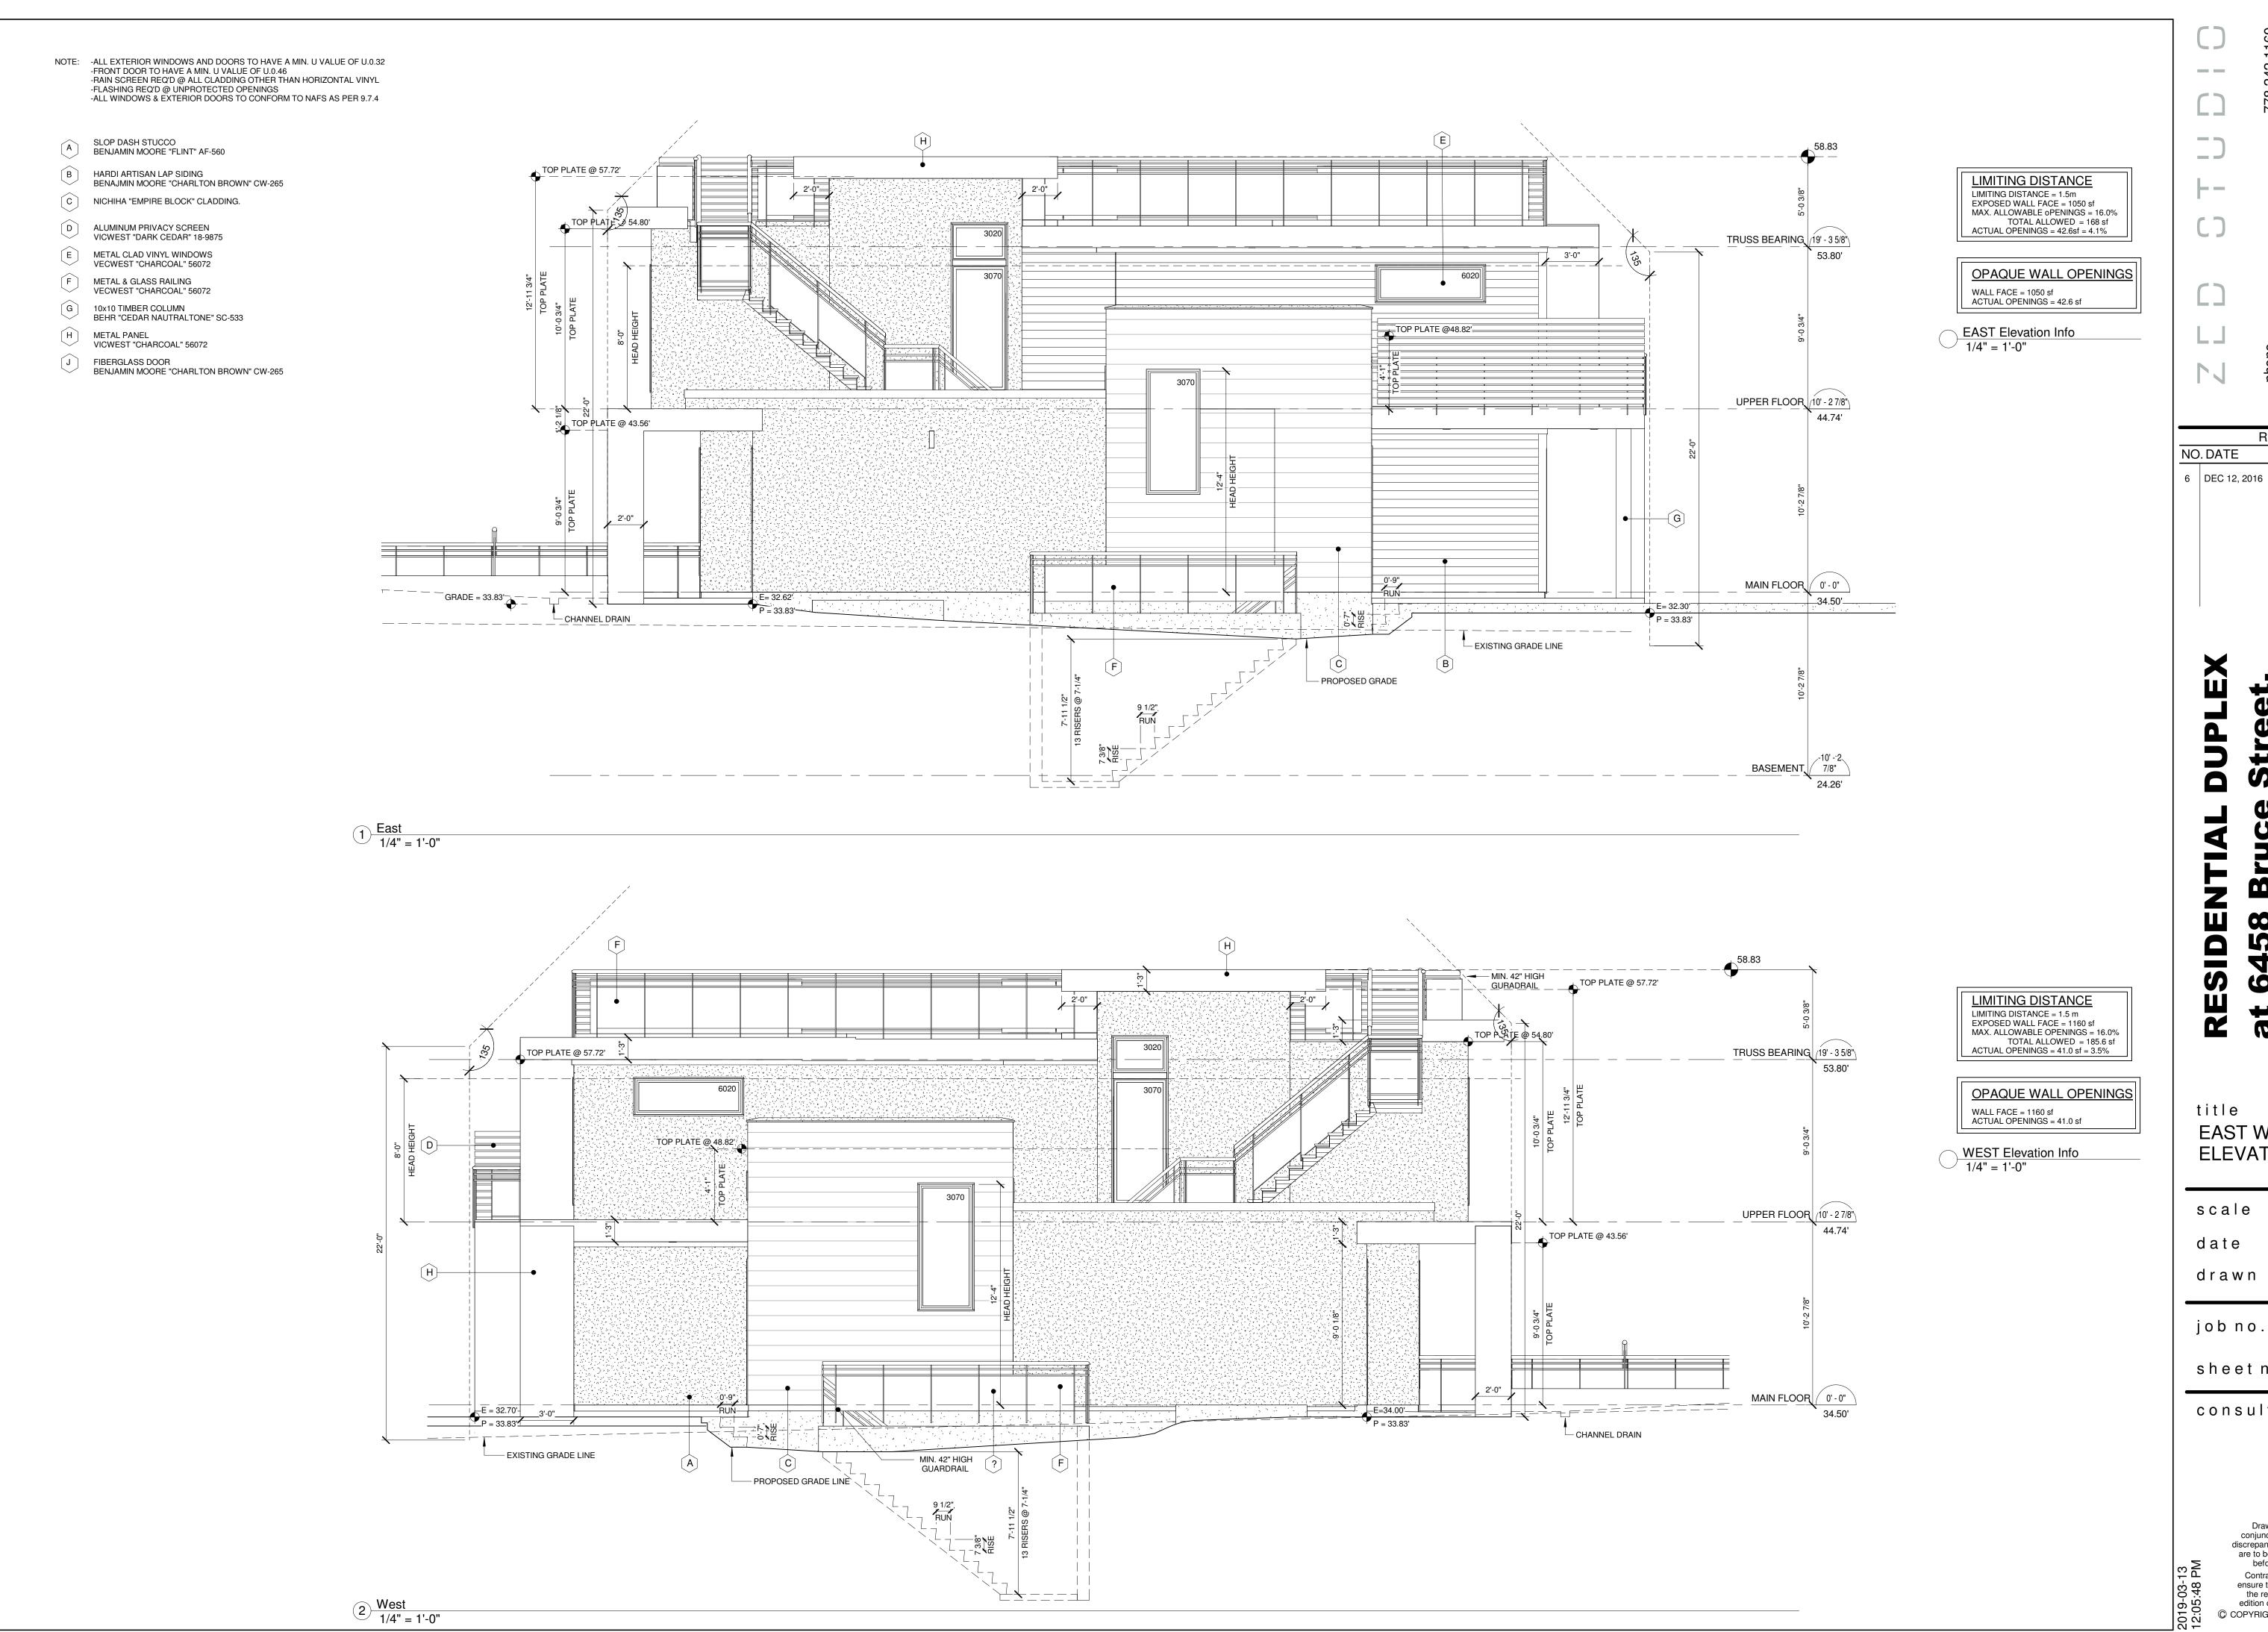
job no. sheet no. A103

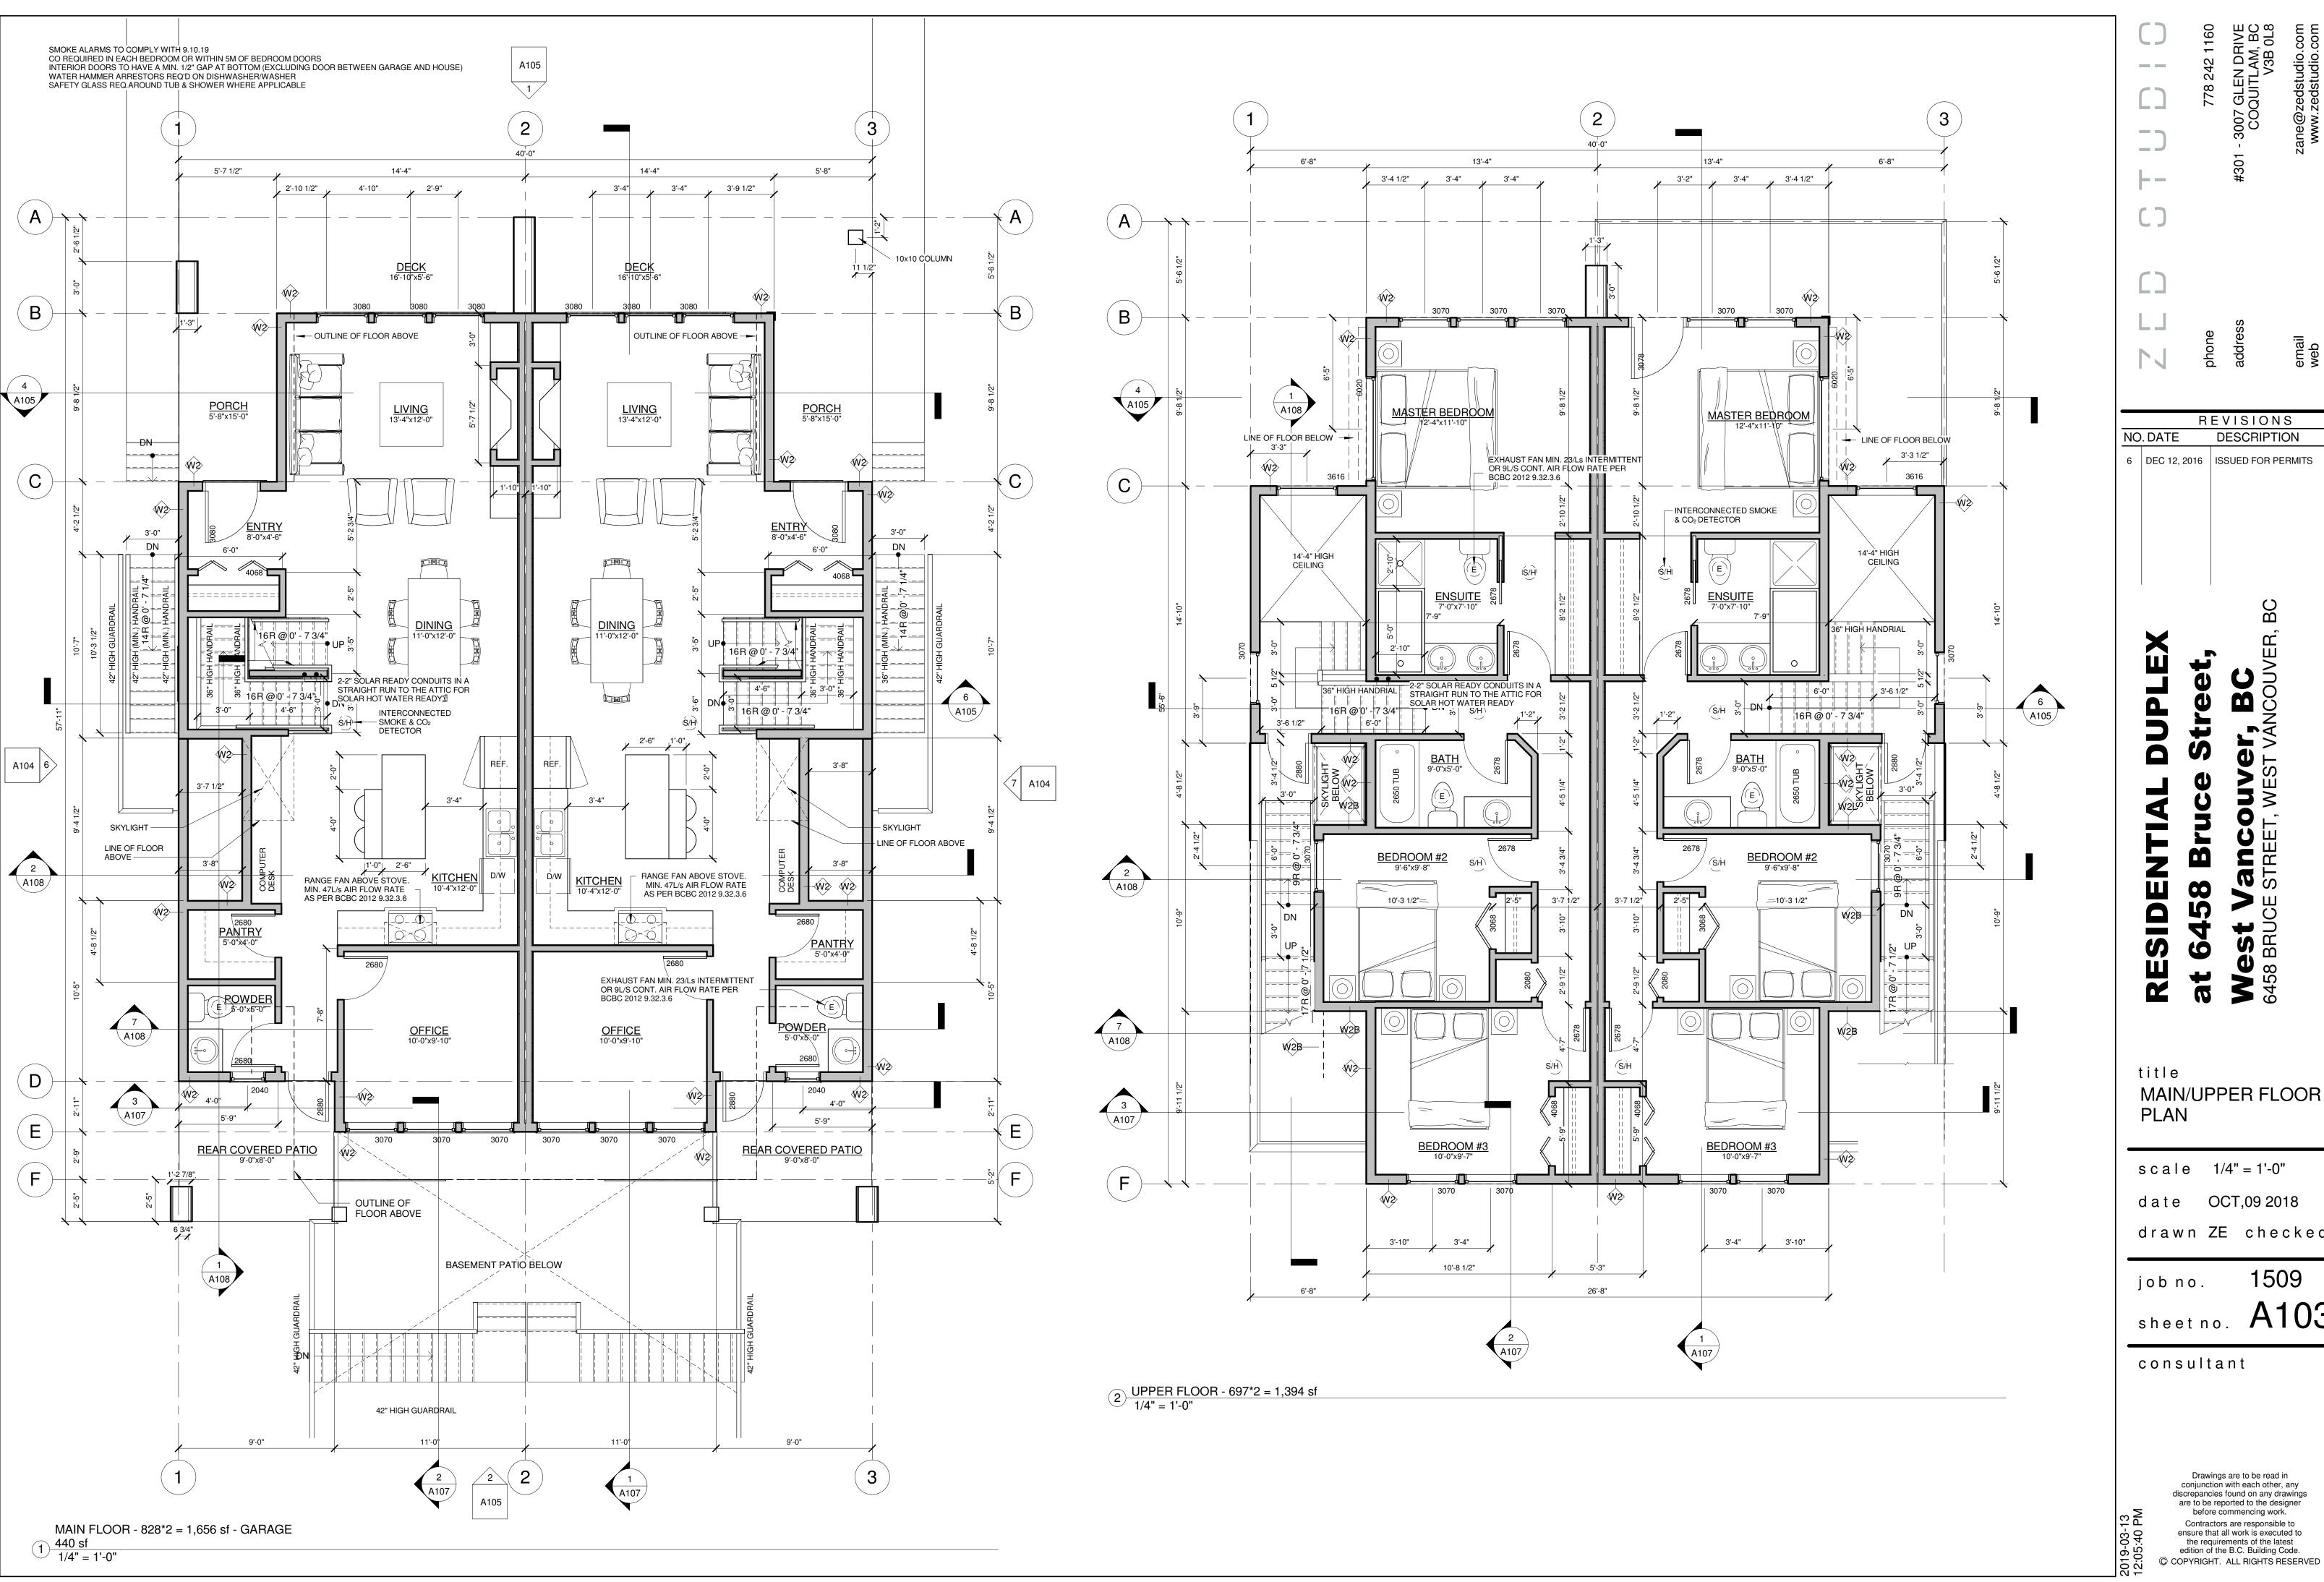consultant

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REVISIONS

NO. DATE DESCRIPTION 6 DEC 12, 2016 ISSUED FOR PERMITS

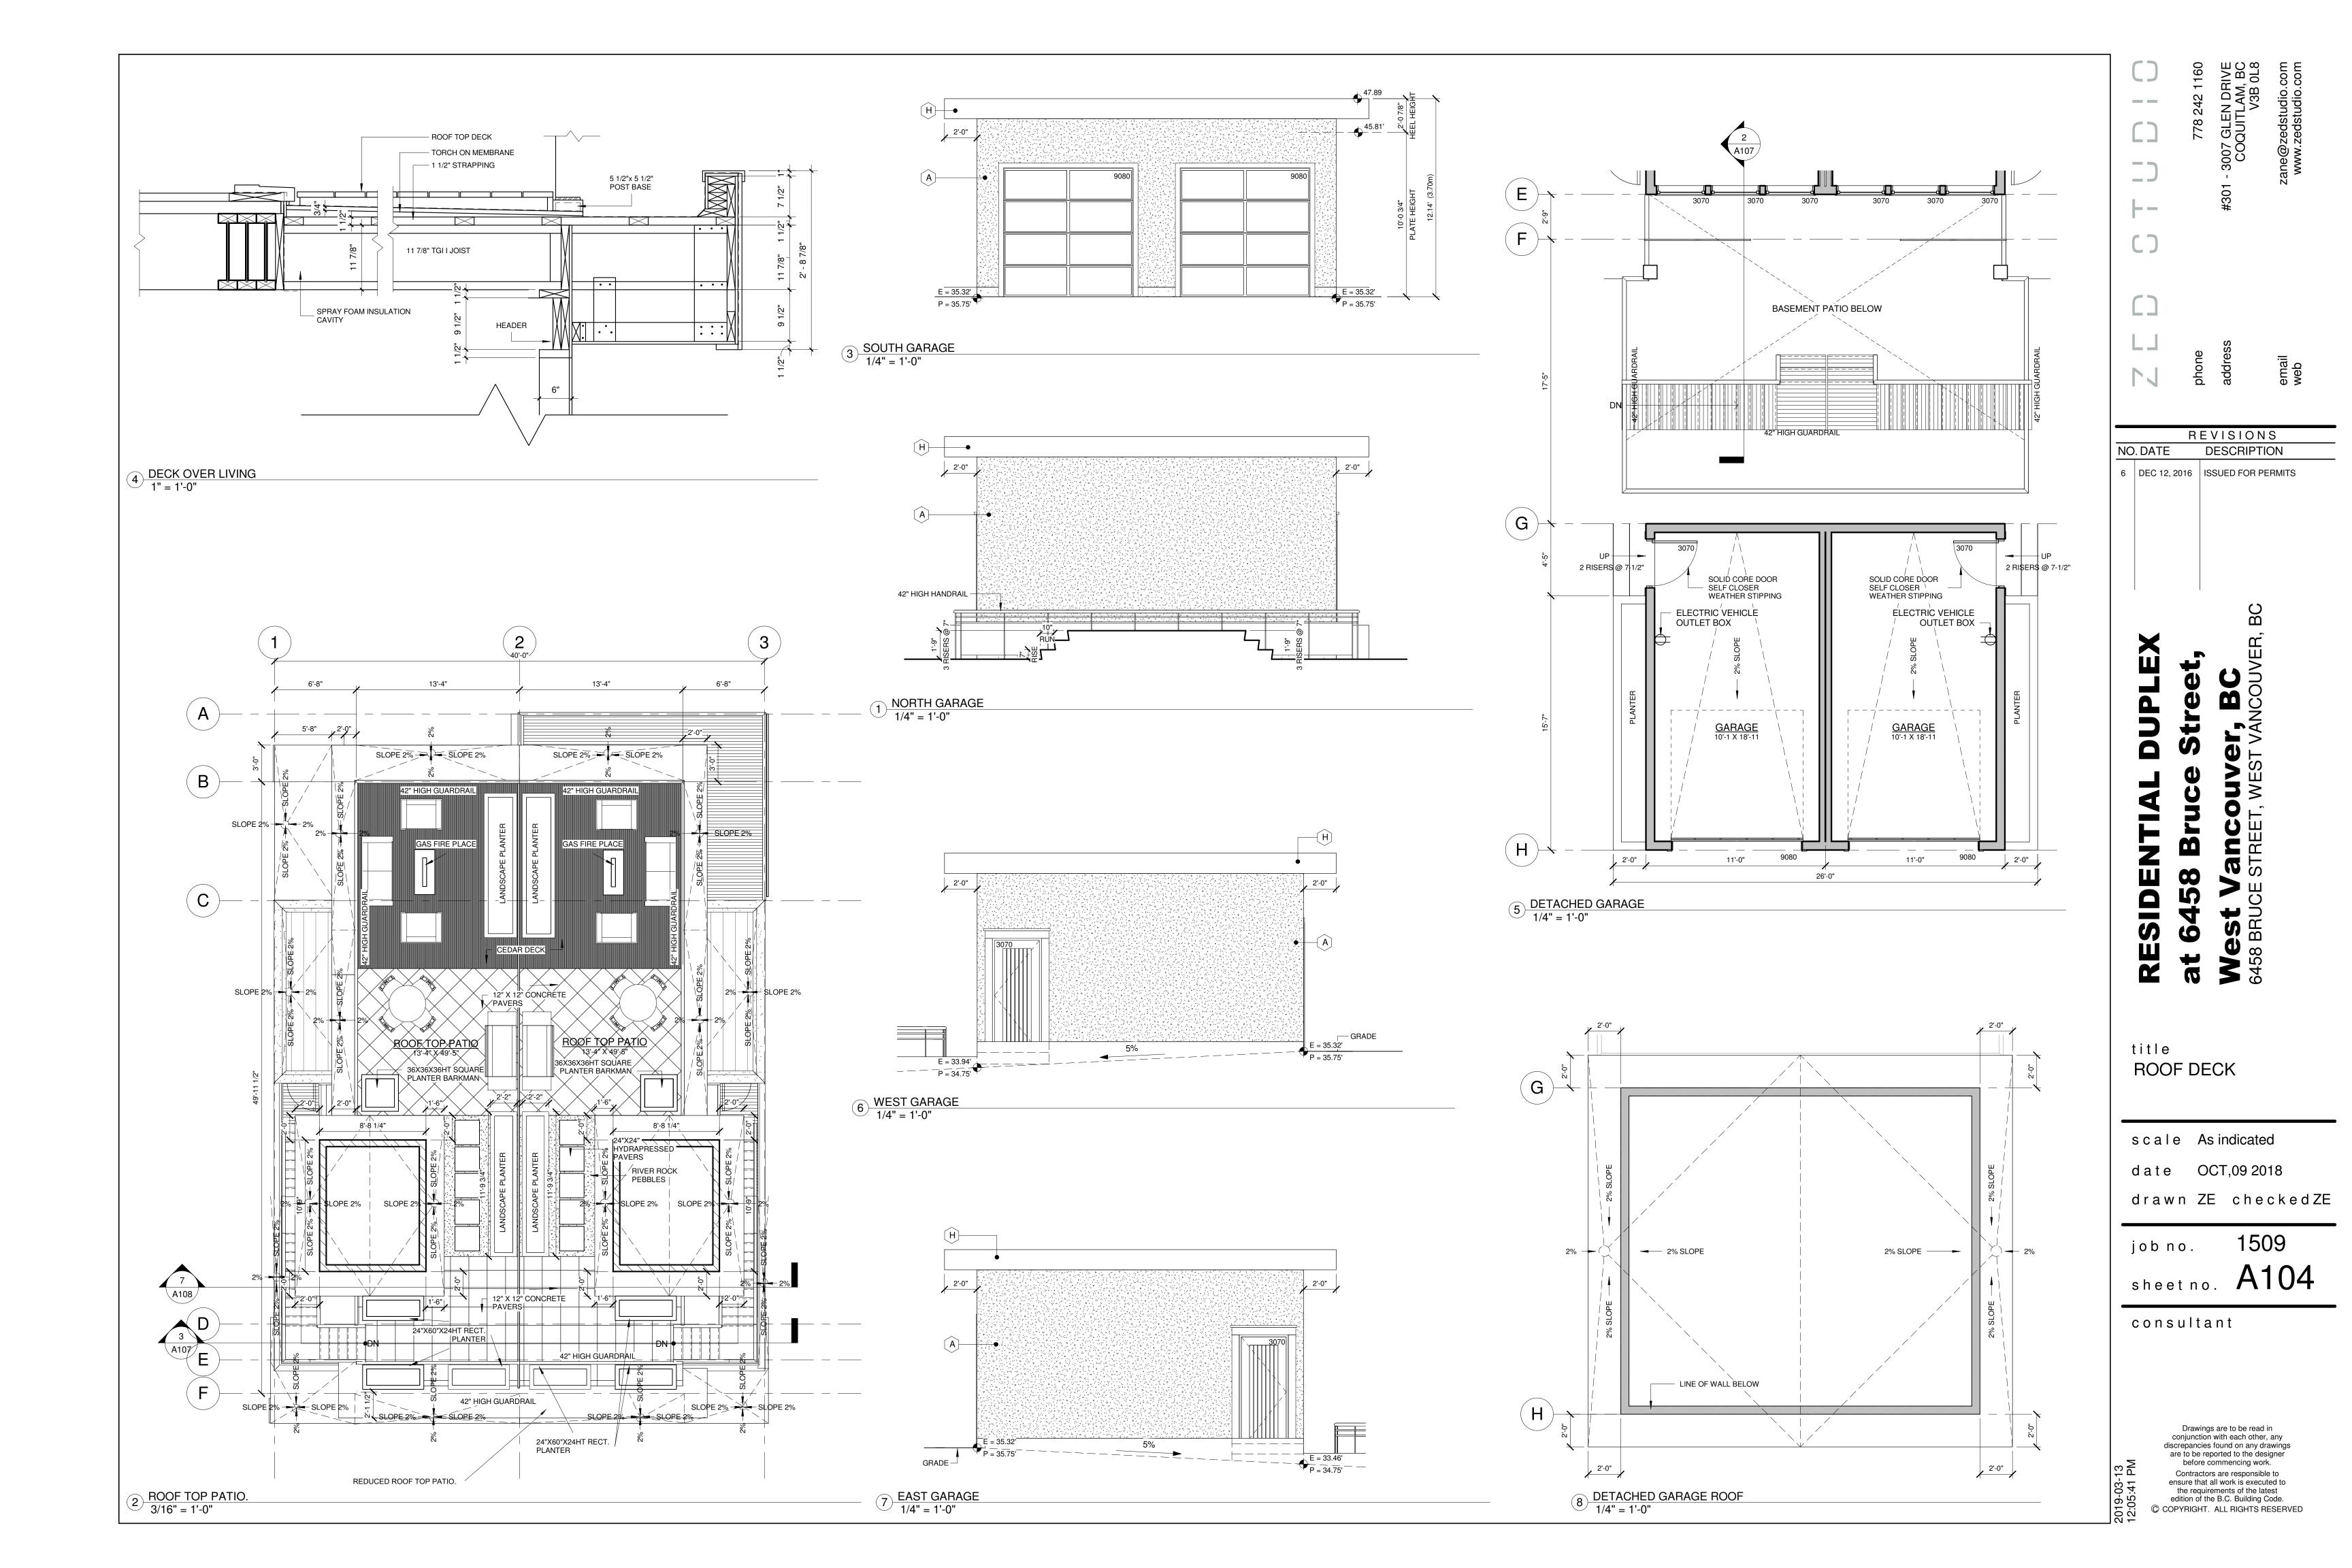EAST WEST ELEVATIONS

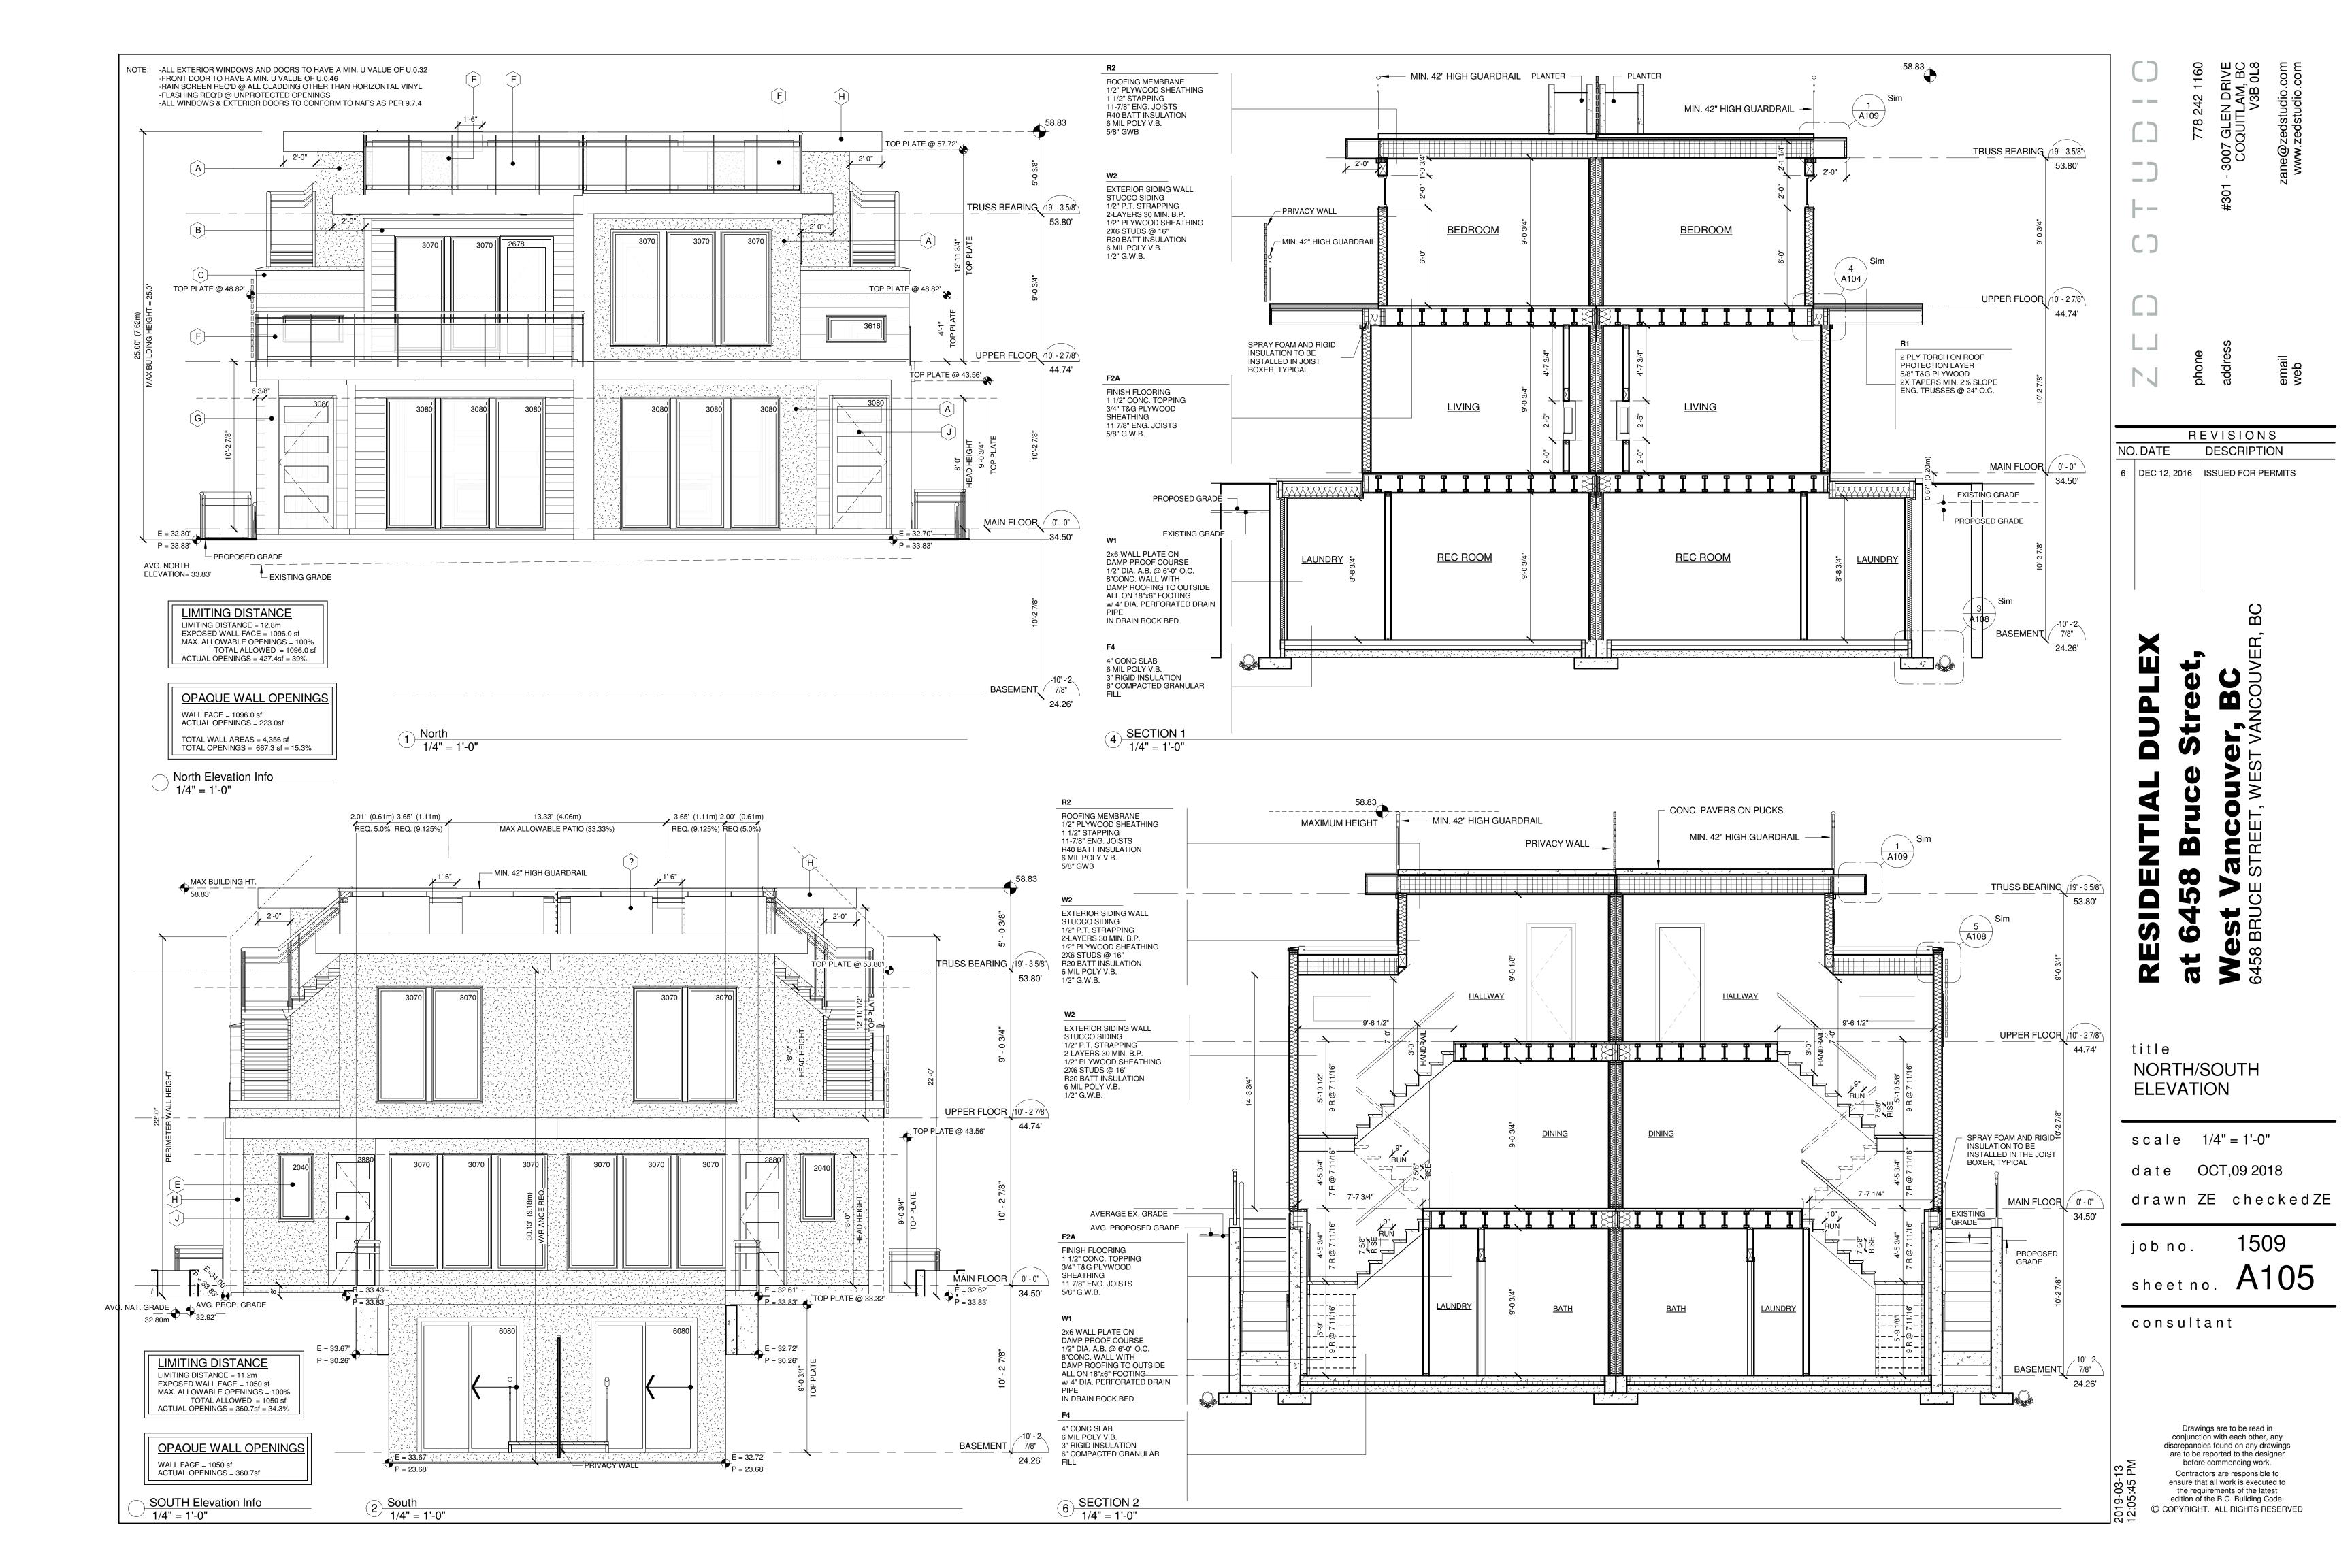
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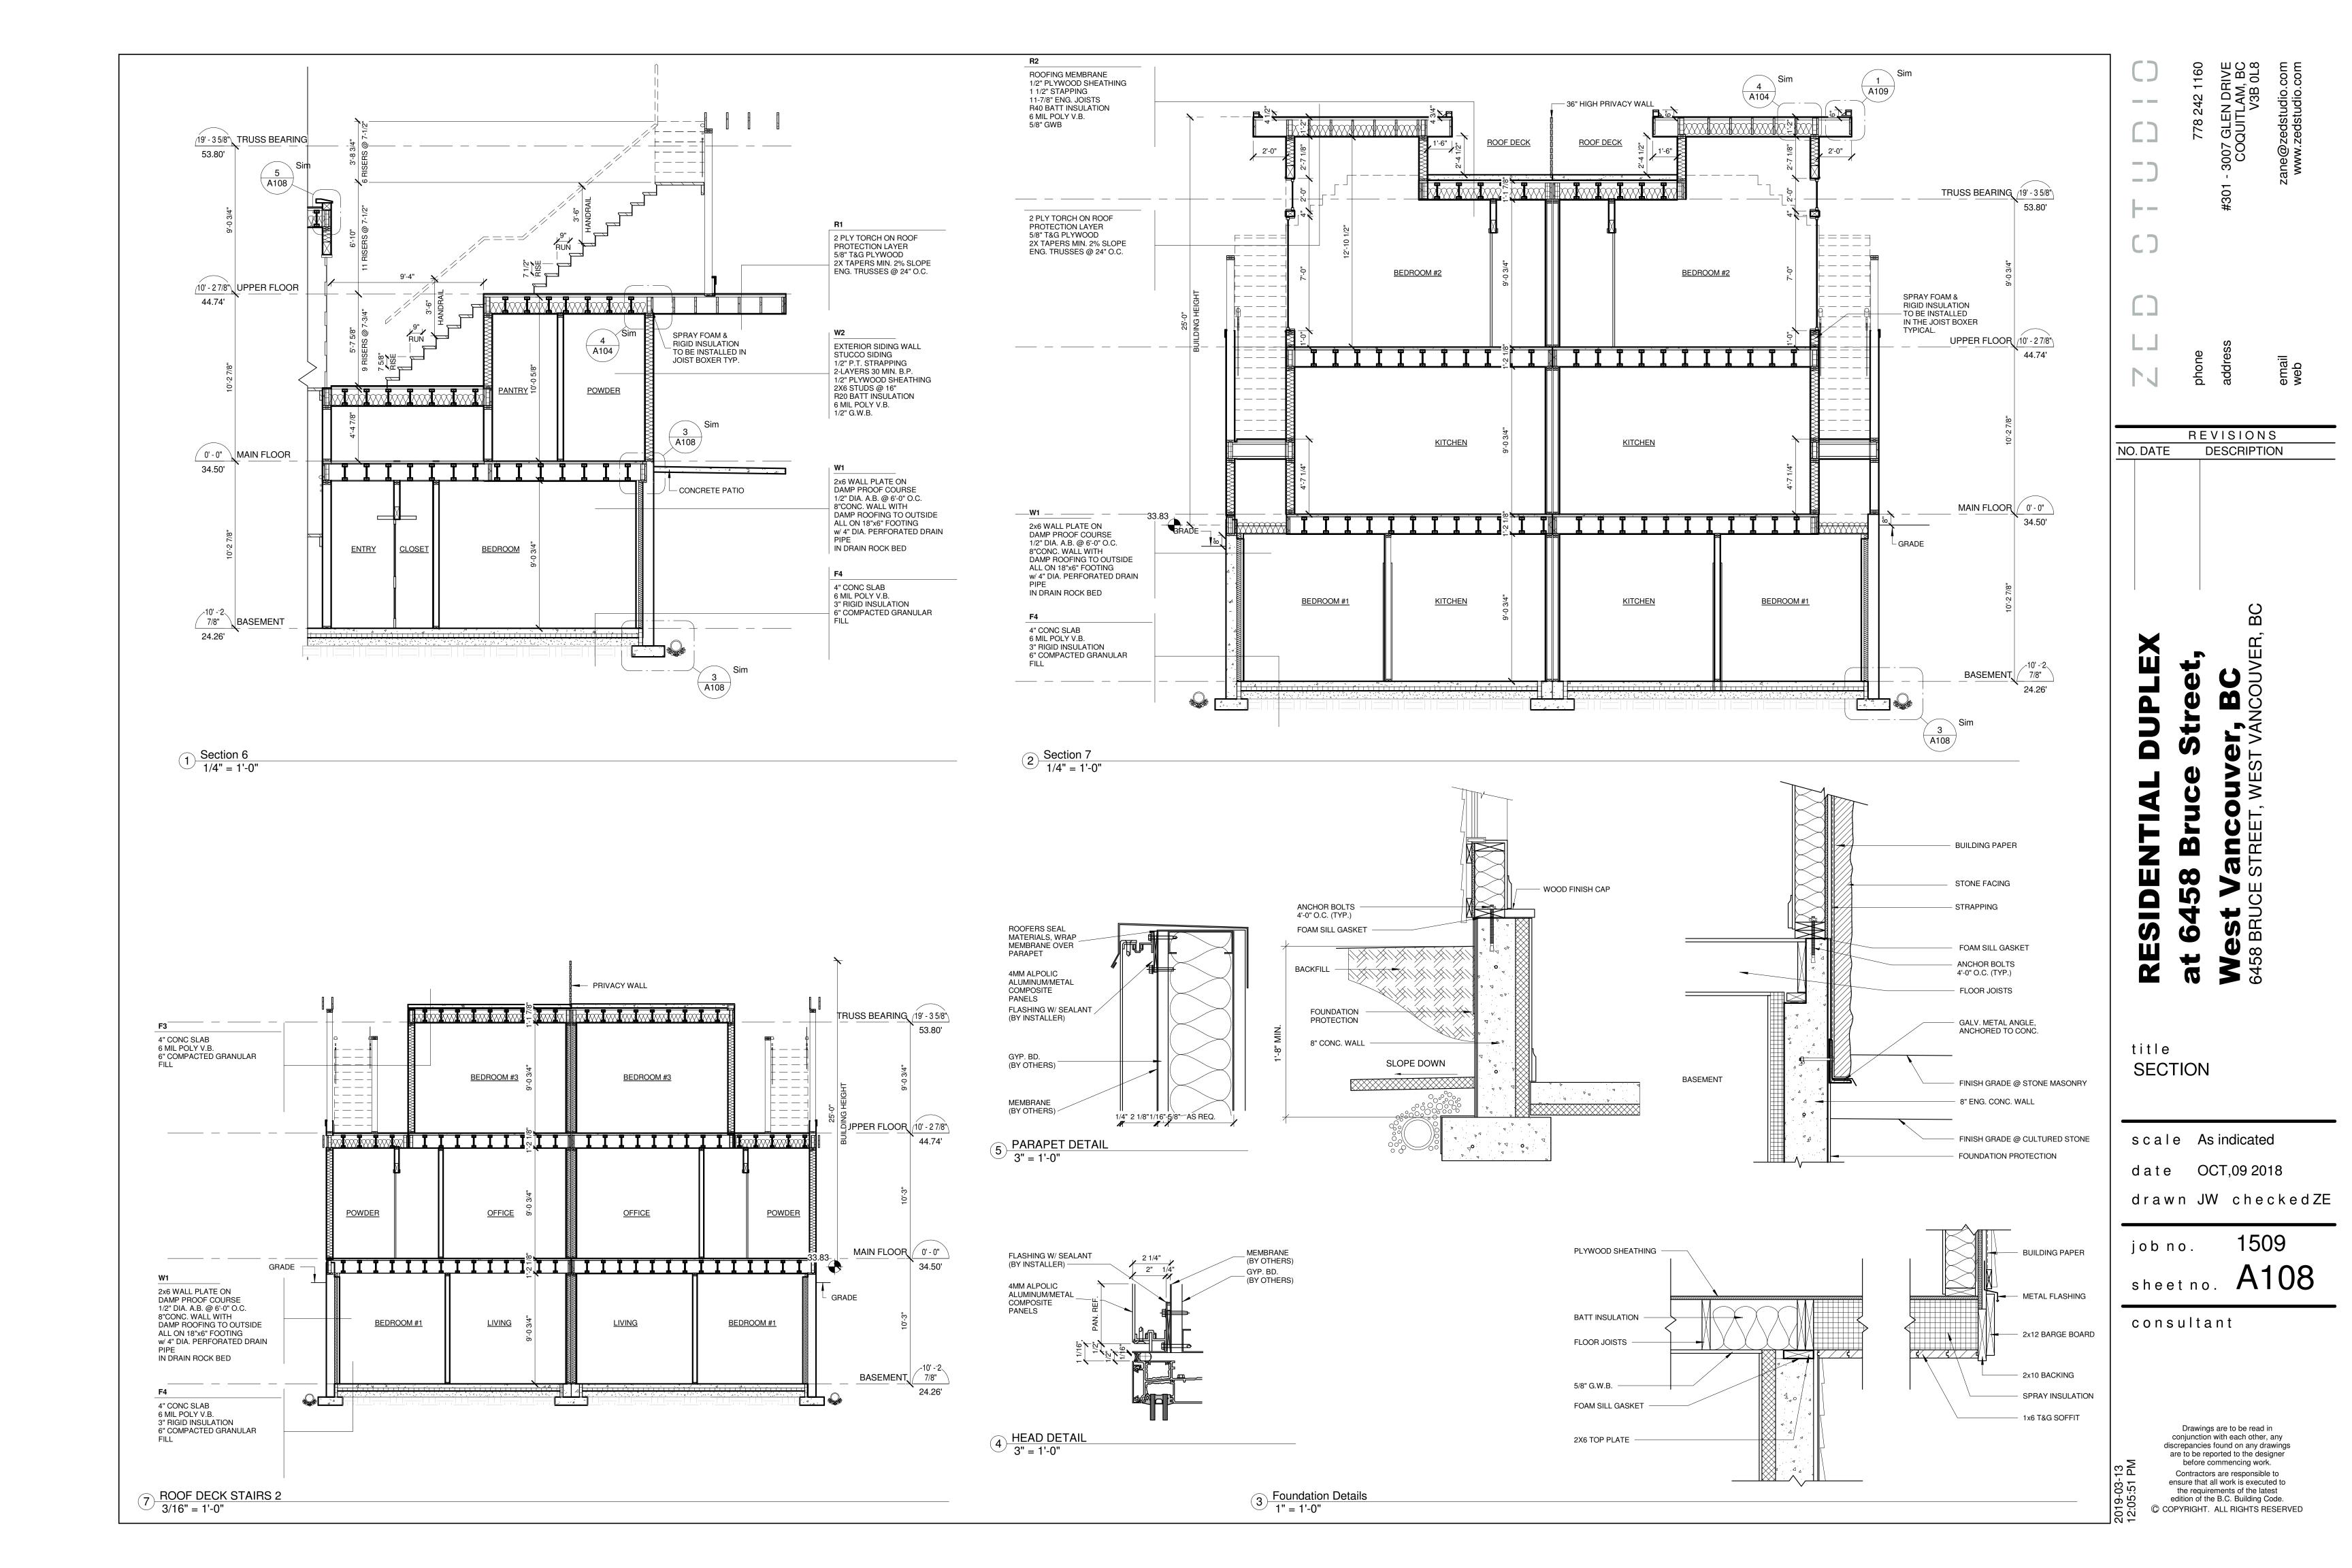
date OCT,09 2018


drawn ZE checkedZE


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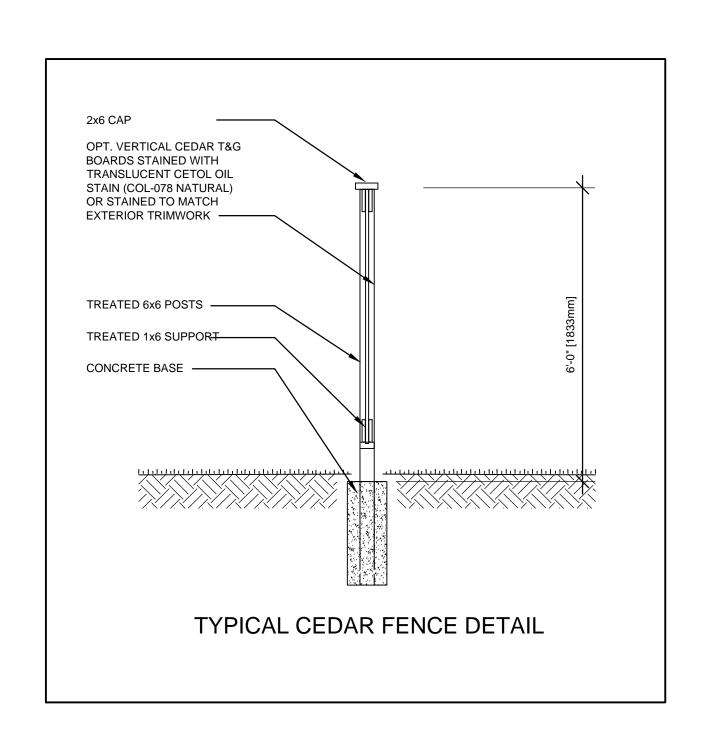
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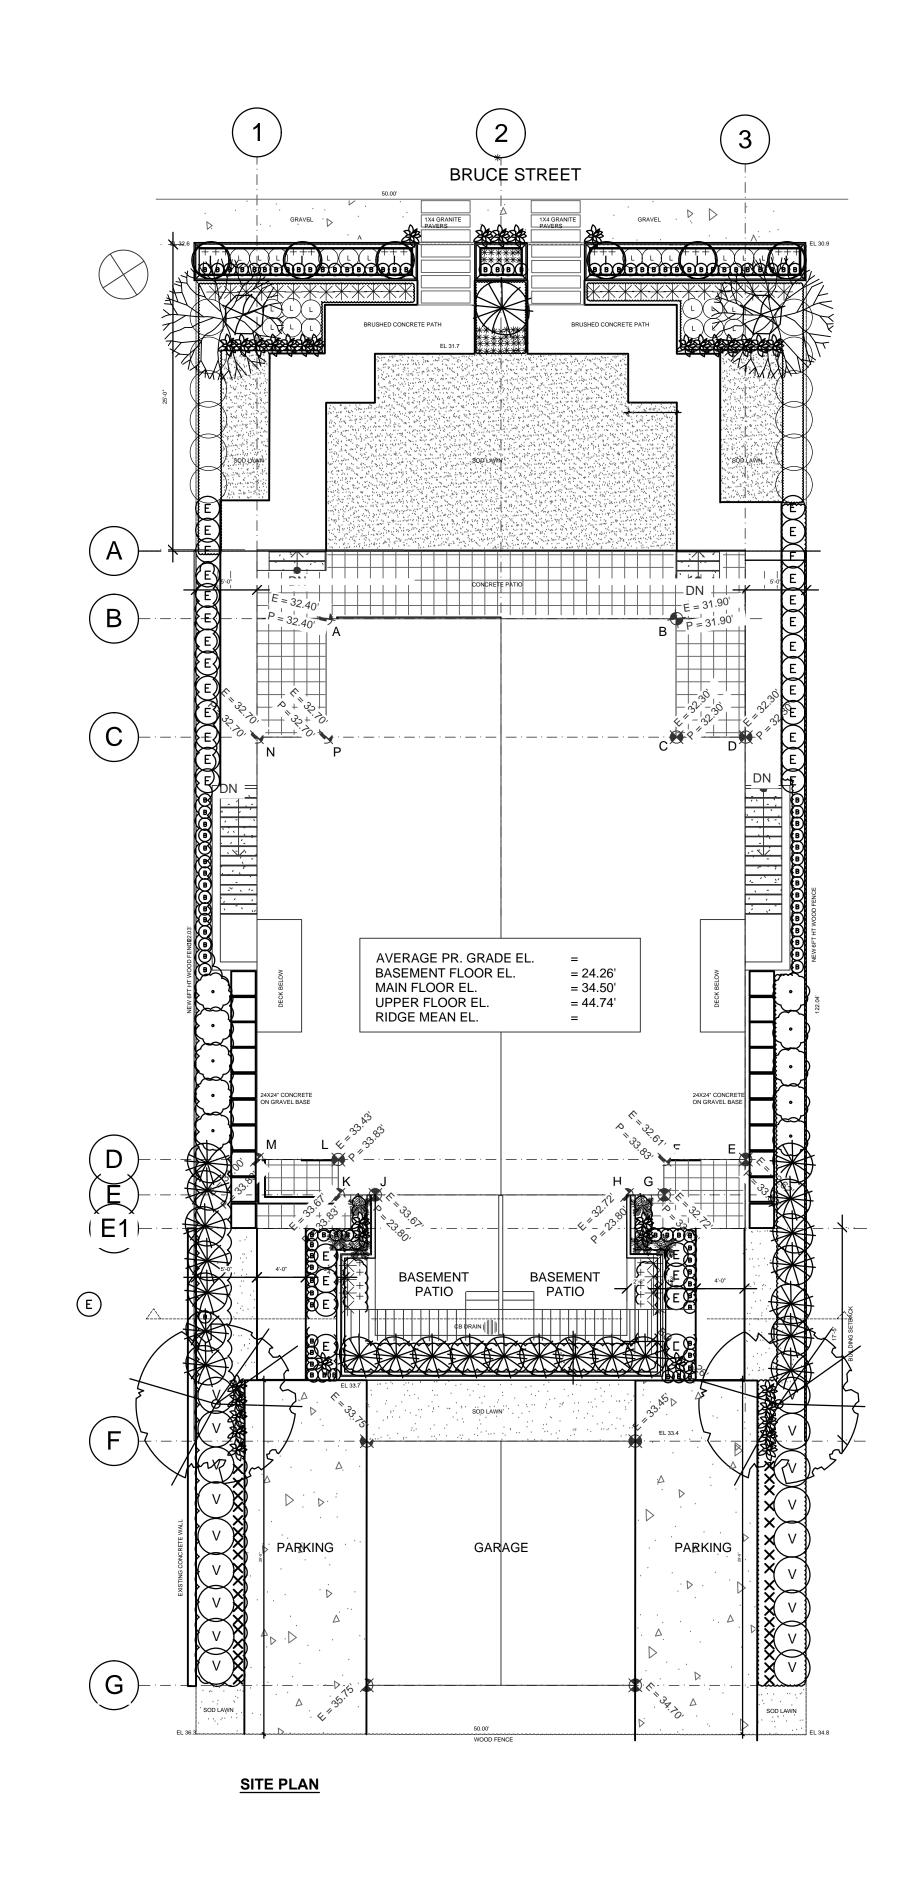






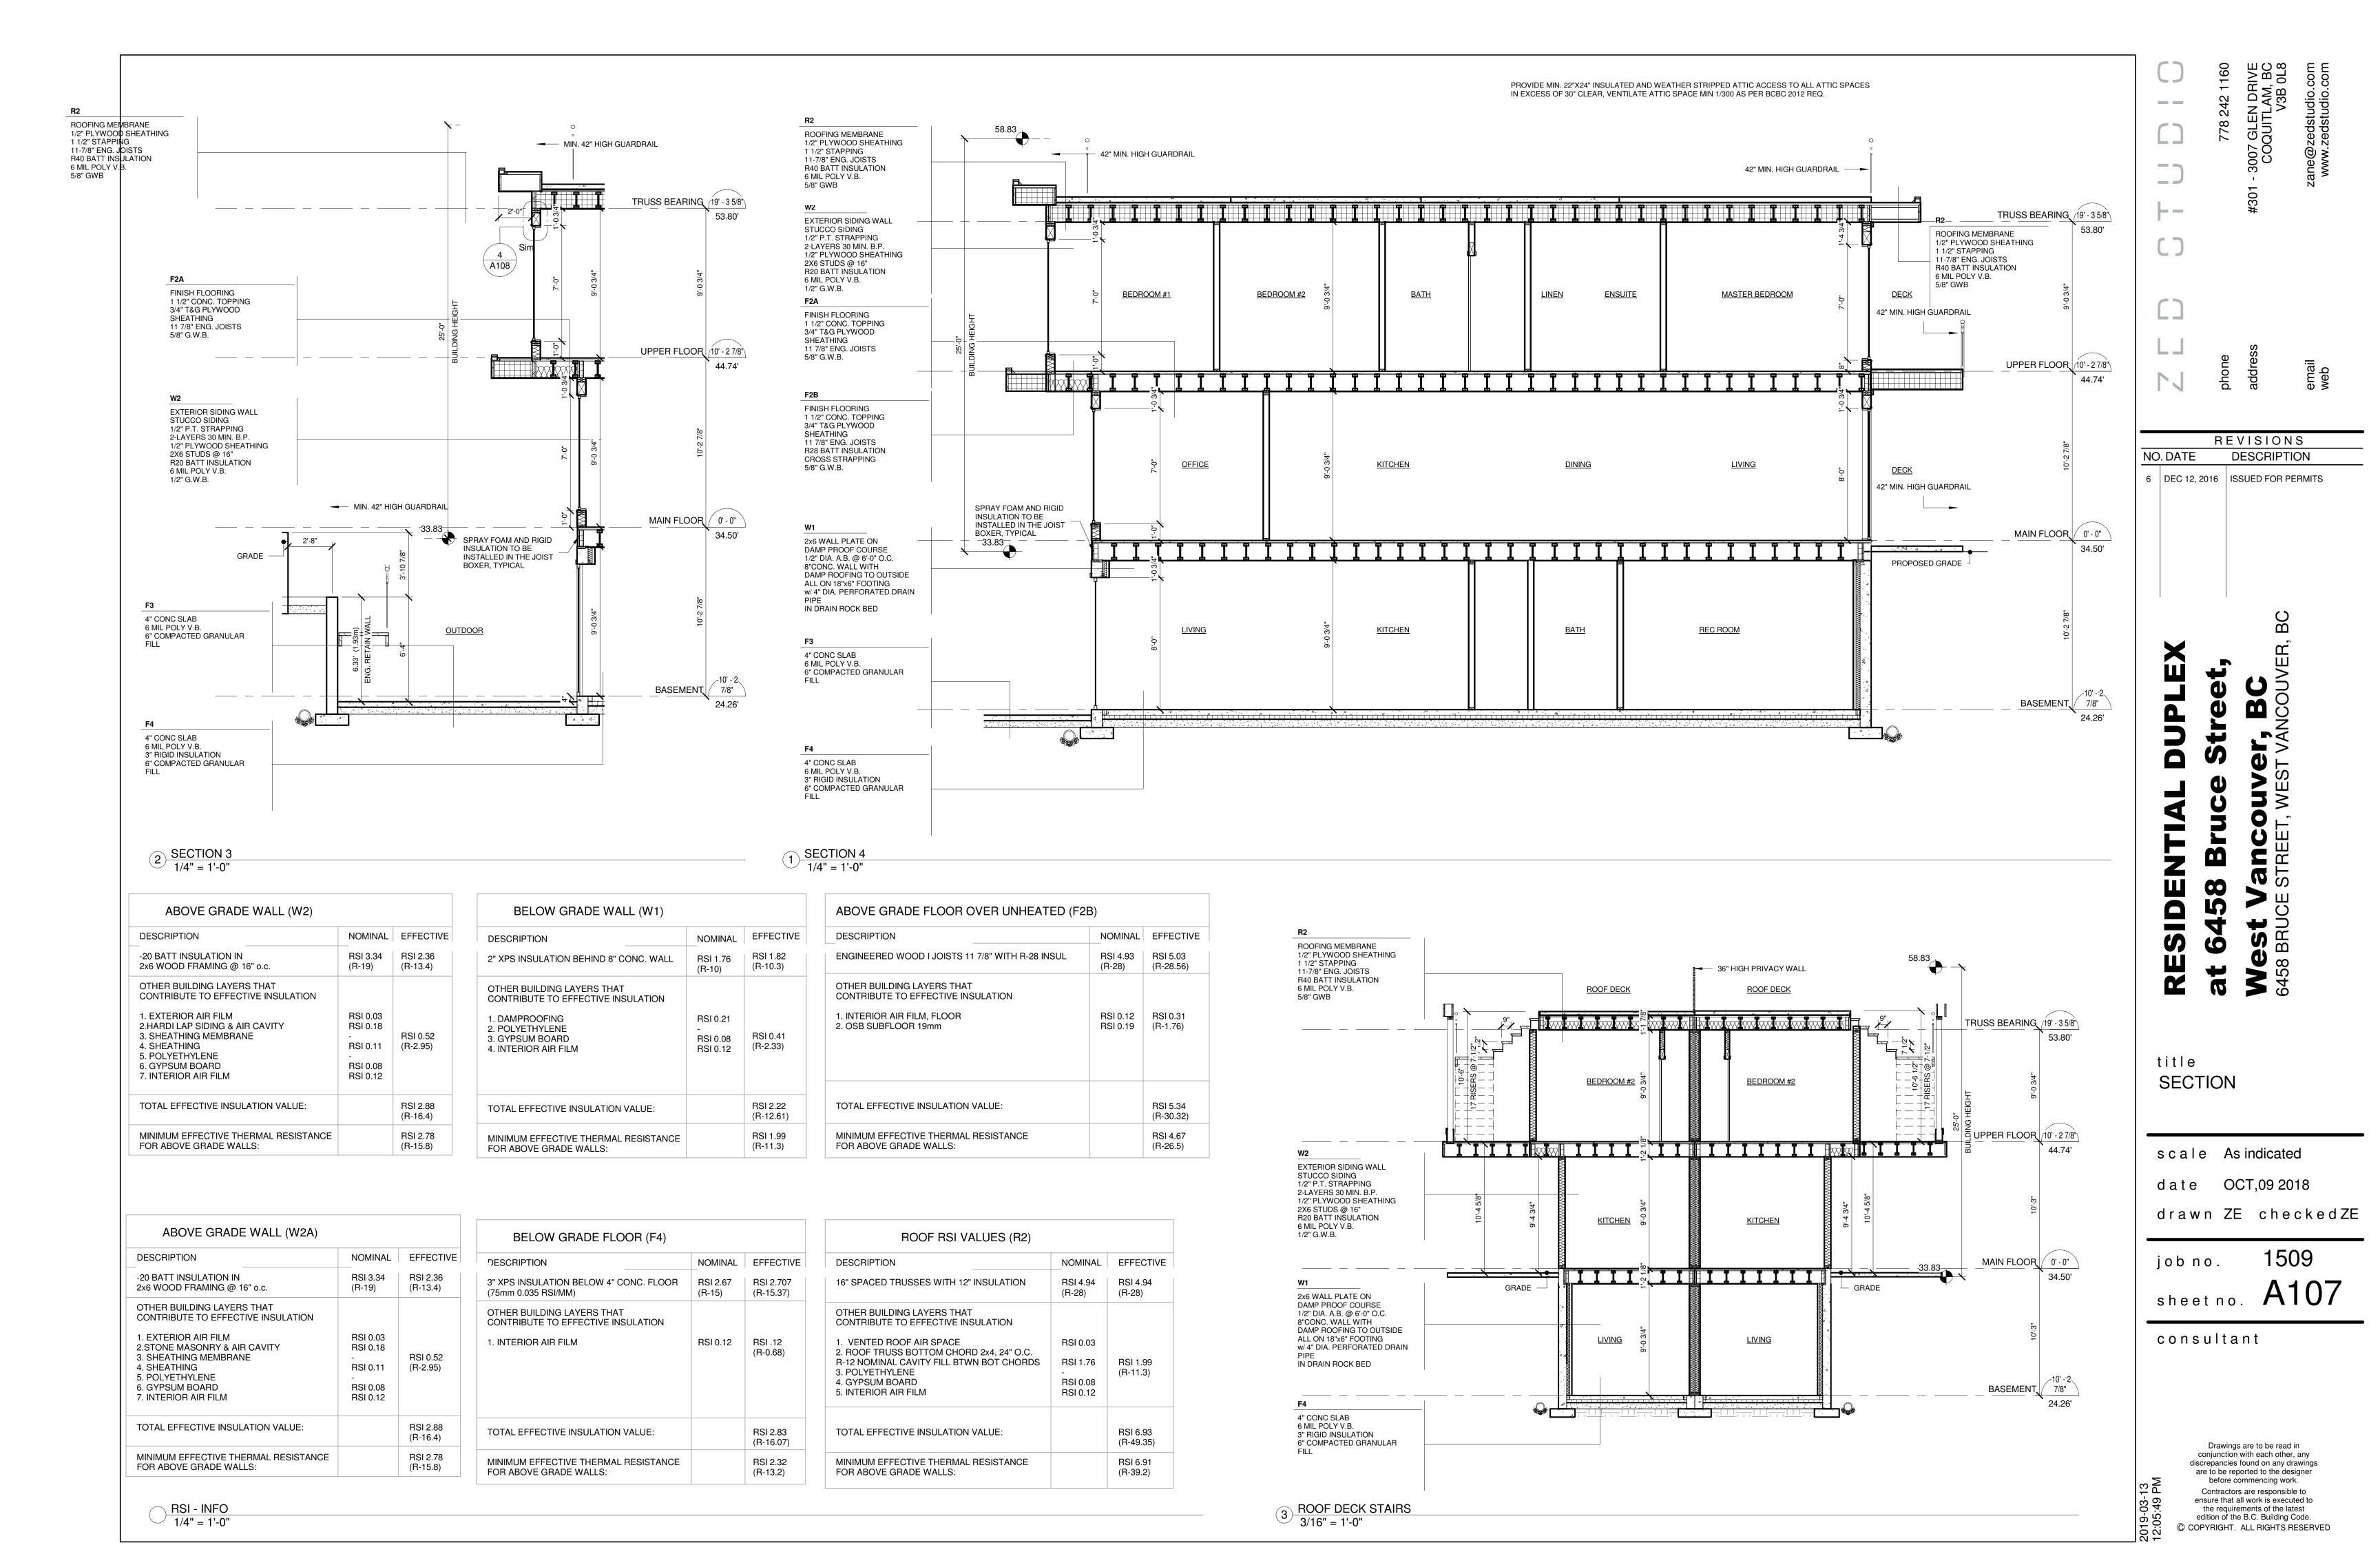

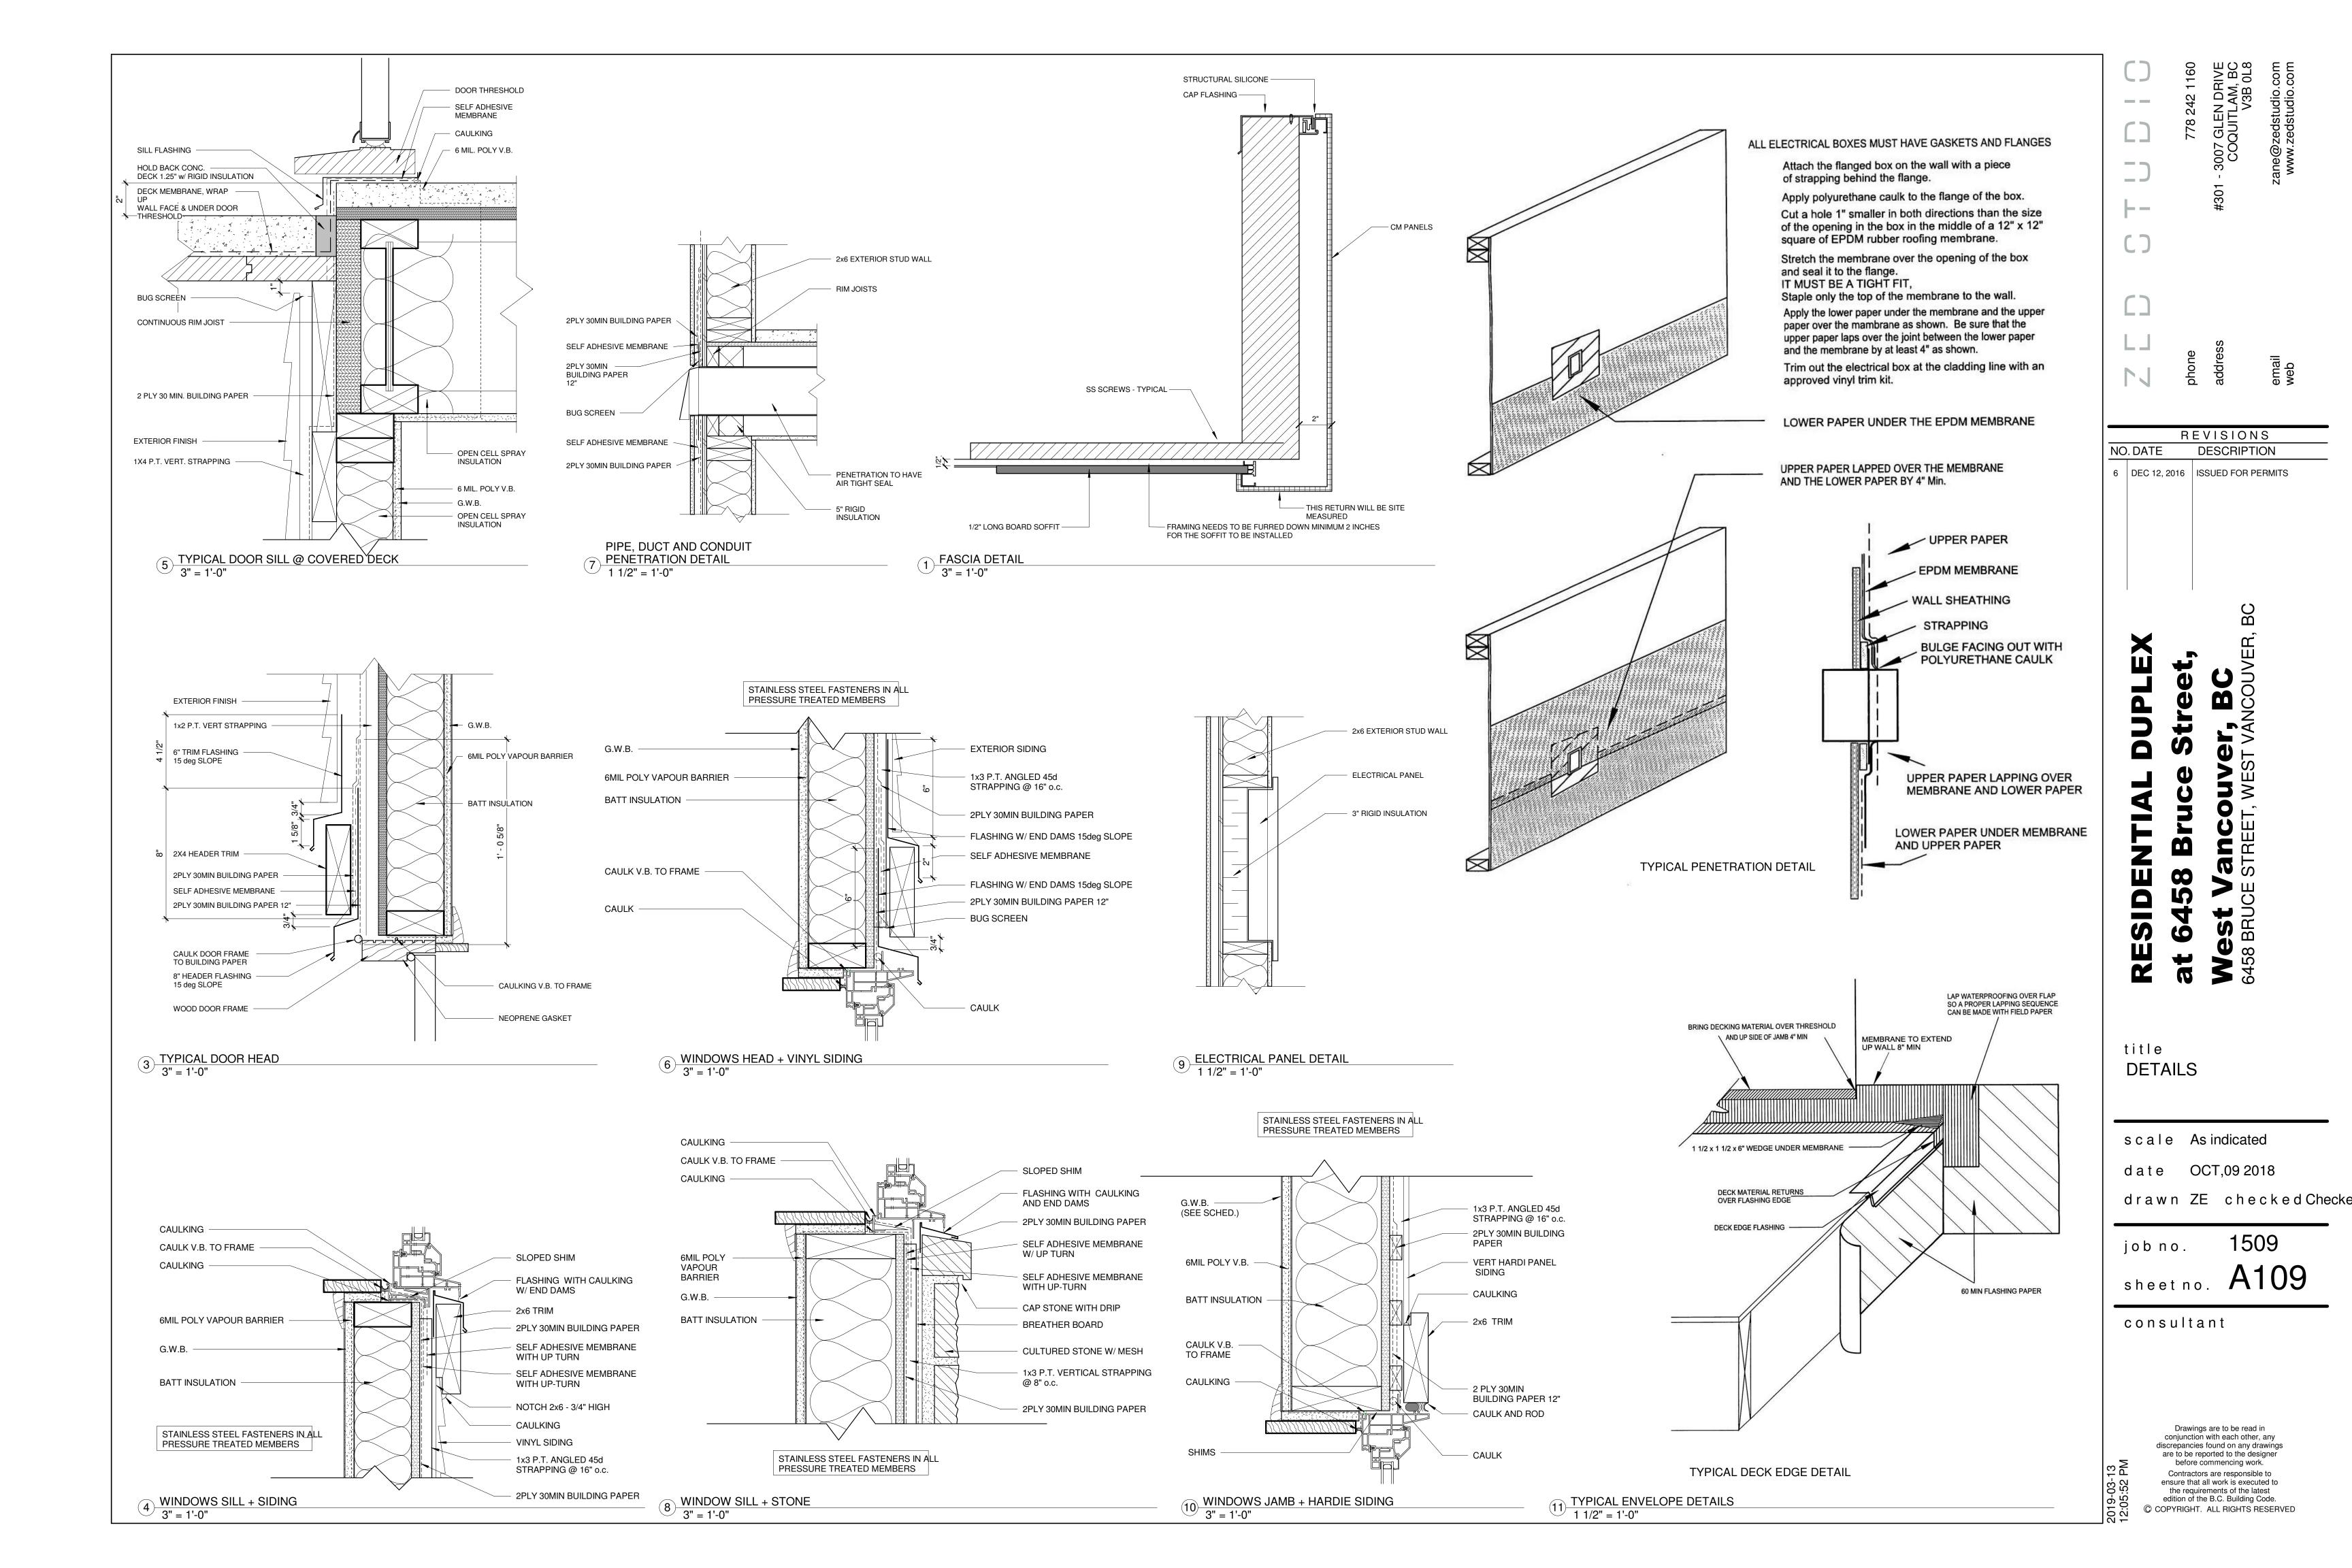

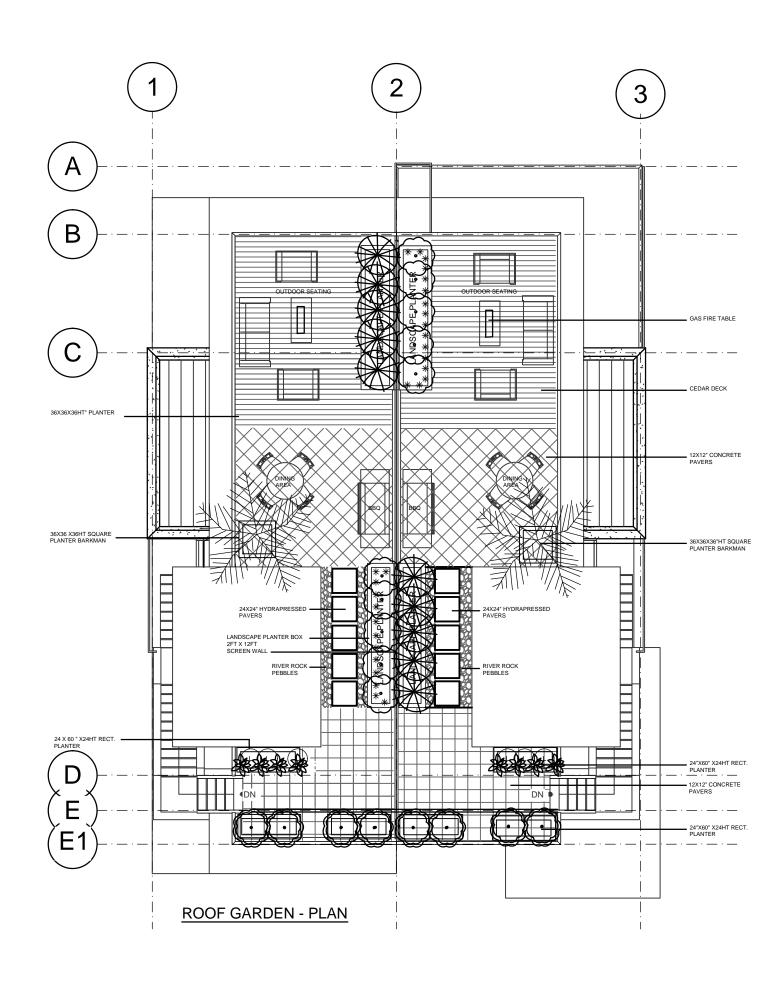


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www.birchstreetdesign.ca

PROJECT:	REVISIONS	DESCRIPTION: DWG		DWG NO.
RESIDENTIAL DUPLEX	NO. DESCRIPTION DATE	LANDSCAPE		110
		PROPOSA	L	LI.U
ADDRESS:		PROJECT NO.	DRAWN BY	,
6458 BRUCE ST	3 ROOF PATIO - GREEN SCREEN 01-23-2017	16007	A. GI	RIFFIOEN
WEST VANCOUVER,BC	2 PLANTING PLAN 07-11-2016		DATE:	E 00 0040
	1 CONCEPTUAL PLAN AND GRADING LAYOUT 06-30-2016	1/8"=1'-0"	JUNE	E 30, 2016





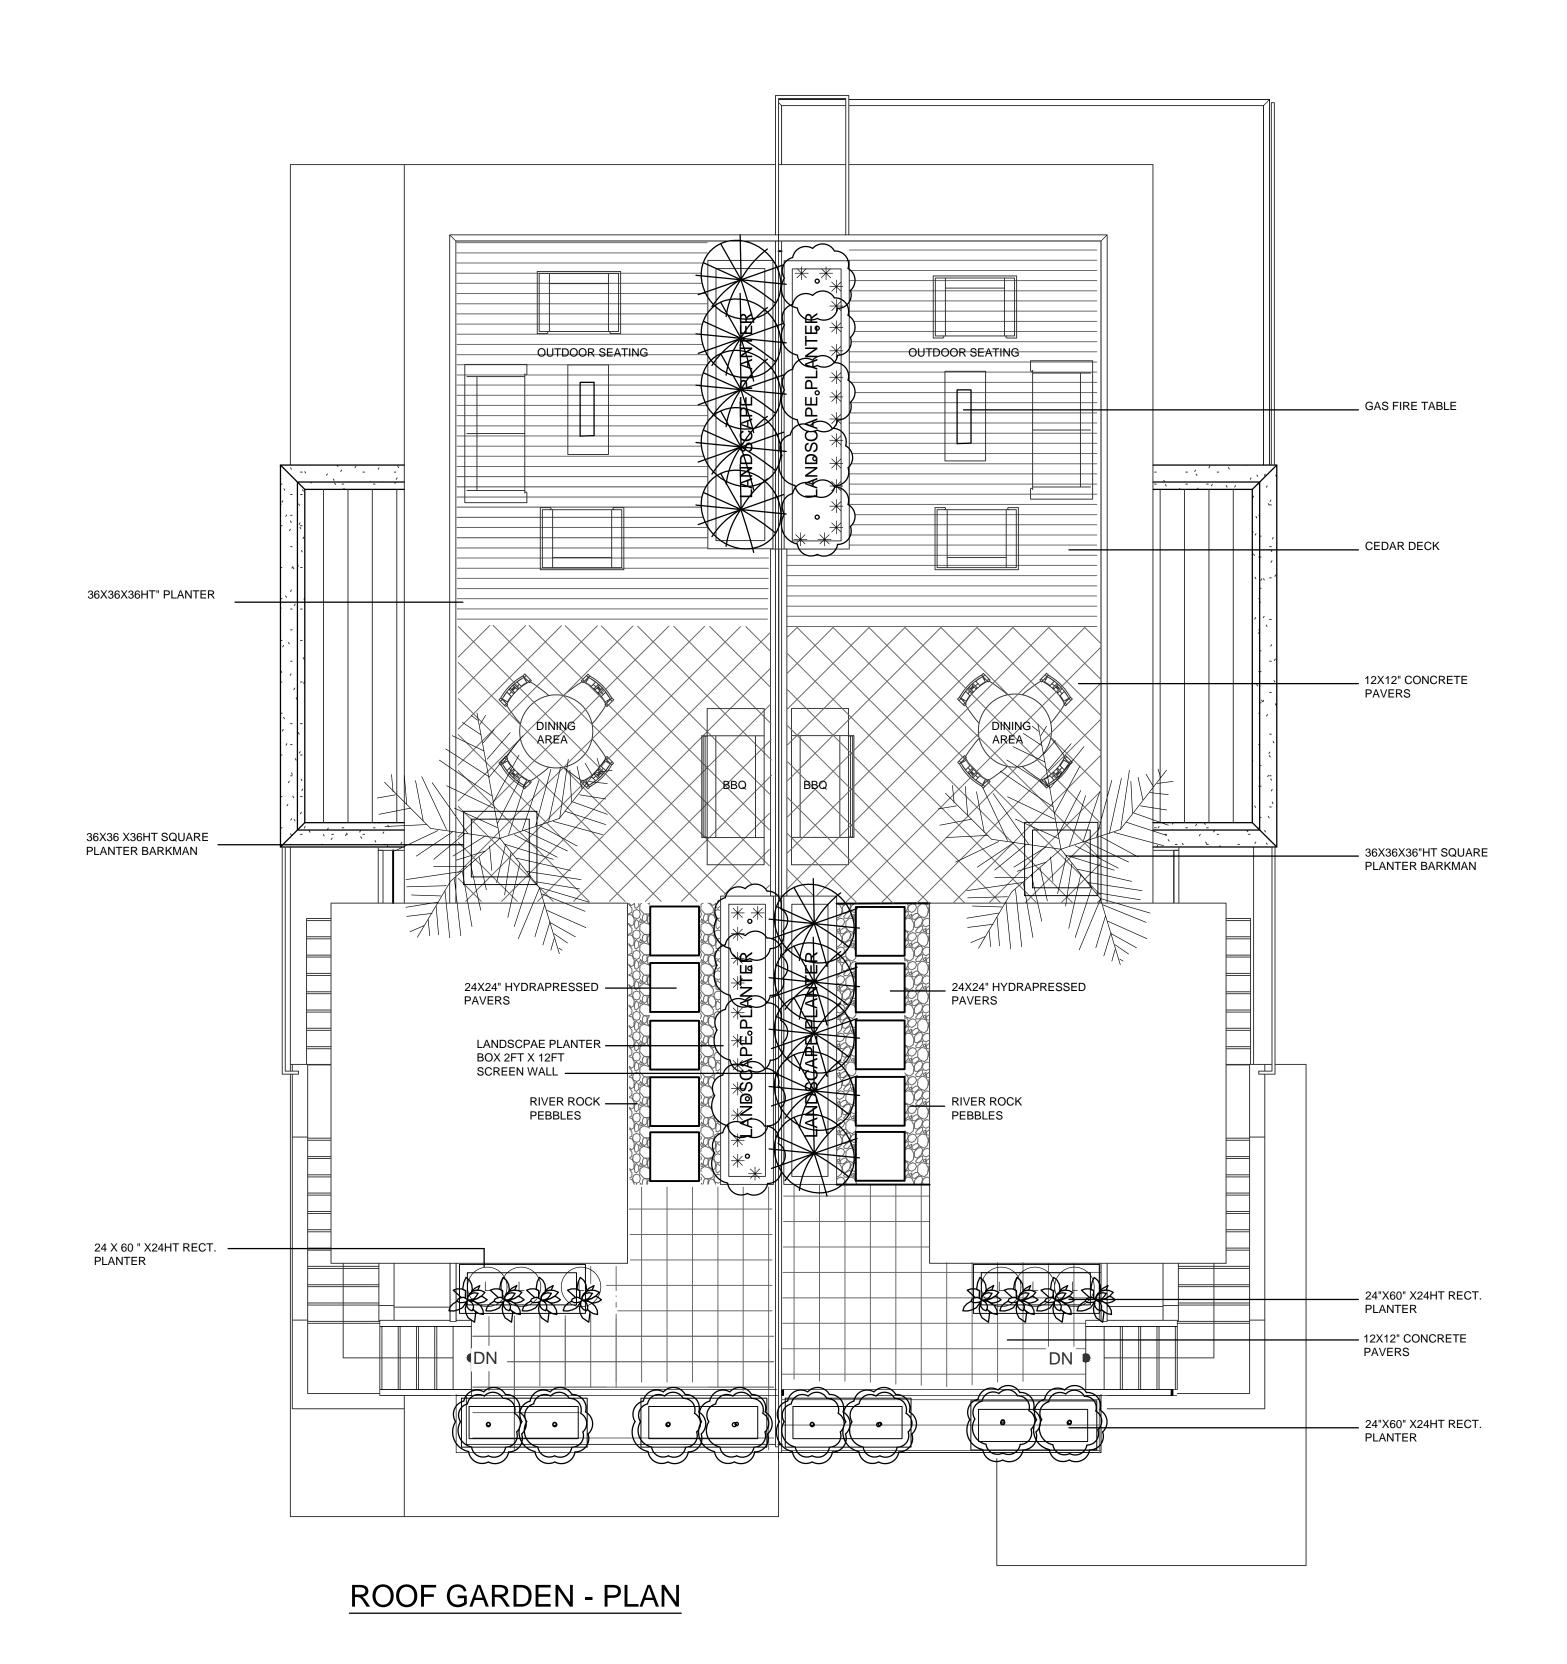





CANTILEVERED WOOD BENCH

HYDRAPRESSED

CONCRETE PAVERS

CEDAR DECK

GAS FIREPIT TABLE

RIVERROCK PEBBLES

CUBE PLANTERS - BARKMAN







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BIRCHSTREET DESIGN STUDIO Alenda Griffioen

TEL 604 755 1689 CELL 604 308 0865 2560 Birch St. Abbotsford, BC, v2S 4H8

www.birchstreetdesign.ca

PROJECT: RESIDENTIAL DUPLEX ADDRESS: 6458 BRUCE STREET,

WEST VANCOUVER, BC

		REVISIONS
	NO.	DESCRIPTION
	3	ROOF PATIO - GREEN SCREEN
	2	DI ANTING DI AN

CONCEPTUAL PLAN AND GRADING LAYOUT

06-30-2016

DWG NO. DESCRIPTION: LANDSCAPE **PROPOSAL** DRAWN BY PROJECT NO. 16007 A. GRIFFIOEN 01-23-2017 SCALE: 07-11-2016 June 30, 2016 1/4"=1'-0"

PLANTING LIST

	BOTA	ANICAL NAME	COMMON NAME	SIZE	<u>QTY</u>	<u>H</u>	<u>S</u>
	TREES						
	Α.	STEWARTIA Pseudocamellia	Japanese Stewartıa	6cm Cal	2	I Om	3m
	В.	STYRAX Japonica	Snowbell Tree	6cm cal	2	I Om	7m
	SHRL	JBS_					
	SA.	Nandina Domestica harbour Dwarf	Heavenly Bamboo	#3 pot	6	2.0m	I.Om
В	SB.	BUXUS SEMPERVIRENS 'WINTER GEM'	Boxwood	# pot	106	I.Om	1.5m
$\overline{\cdot}$	SC.	PINUS MUGHO "Pumilo"	Dwarf Mugo Pine	# 5 pot	12	0.75m	ı I.Om
*	SD.	YUCCA FILAMENTOSA 'Aurea'	Golden striped Yucca	# 2 pot	5	0.75m	n 0.5m
\bigotimes	SE.	HYDRANGEA ARBORECENS 'Annabelle'	Annabelle Hydrangea	# 5 pot	2	1.25m	1.5m
L	SF.	LAVANDULA ANGUSTIFOLIA 'Blue Cushion'	Blue Cushion Lavender	# 2 pot	30	I.Om	I.Om
	SG.	PICEA ABIES 'pendula'	Weeping Nest spruce	# 2 pot	1	1.2m	I.Om
V	SH.	VIBURNUM DAVIDII	David's Viburnum	# 2 pot	18	I.Om	I.Om
\bigcirc	SI.	SKIMMIA JAPONICA REEVESIANA	Japanese Skimmia M/F	# 3 pot	10	1.5m ().6m
E	SJ.	EUONYMOUS FORTUNEI 'green n white '	Groundcover Euonymou	s#1pot	36	lm l	.Om
\odot	SK.	Aucuba japonica	Crotonifolia	# 3 pot	10	Ιm	Ιm
	SL.	Aucuba japonica	Crotonifolia	# 3 pot	34	Ιm	0.5m
	SM.	PHOENIX ROEBELINI	Date palm	# 5 pot	2	lm l	.2
0	SN.	THUJA OCCIDENTALIS 'SMARAGD'	Smaragd Cedar	# 3 pot	8	1.Om ().5m
	CROI	JNDCOVERS					
*			\/	# 1	C.C.	0.2	0.2
\star		CAREX OSHIMENSIS 'EVERGOLD'	Var Japanese Sedge	# pot	66		0.3m
+	GB.	CALAMAGROSTIS KARL FOERSTER	Feather reed grass	# Pot	32	I.2m	0.5m
×	GC.	RUDBECKIA	Black eyed susan	# pot	32	0.5	0.5m
ALL.	GD.	GAULTHERIA SHALLON	Salal	# pot	50	0.3m	0.2m

LAWN AREAS - sod lawn min 6 " topsoil

HOSTA VAR

BLECHNUM SPICANT

GG. COTONEASTER DAMMERII

BARKMULCH - min 4" THICK COMPOSTED BARKMULCH

TOPSOIL - Plantng areas min 6-12" depth - groundcovers 18-24' depth - shrubs

18-24' depth - shrubs 36" depth - trees

Hosta

Bearberry


Western sword fern


| pot

0.3m 0.3m

 $0.3m \ 0.3m$

| POT 26 0.25m | .0m

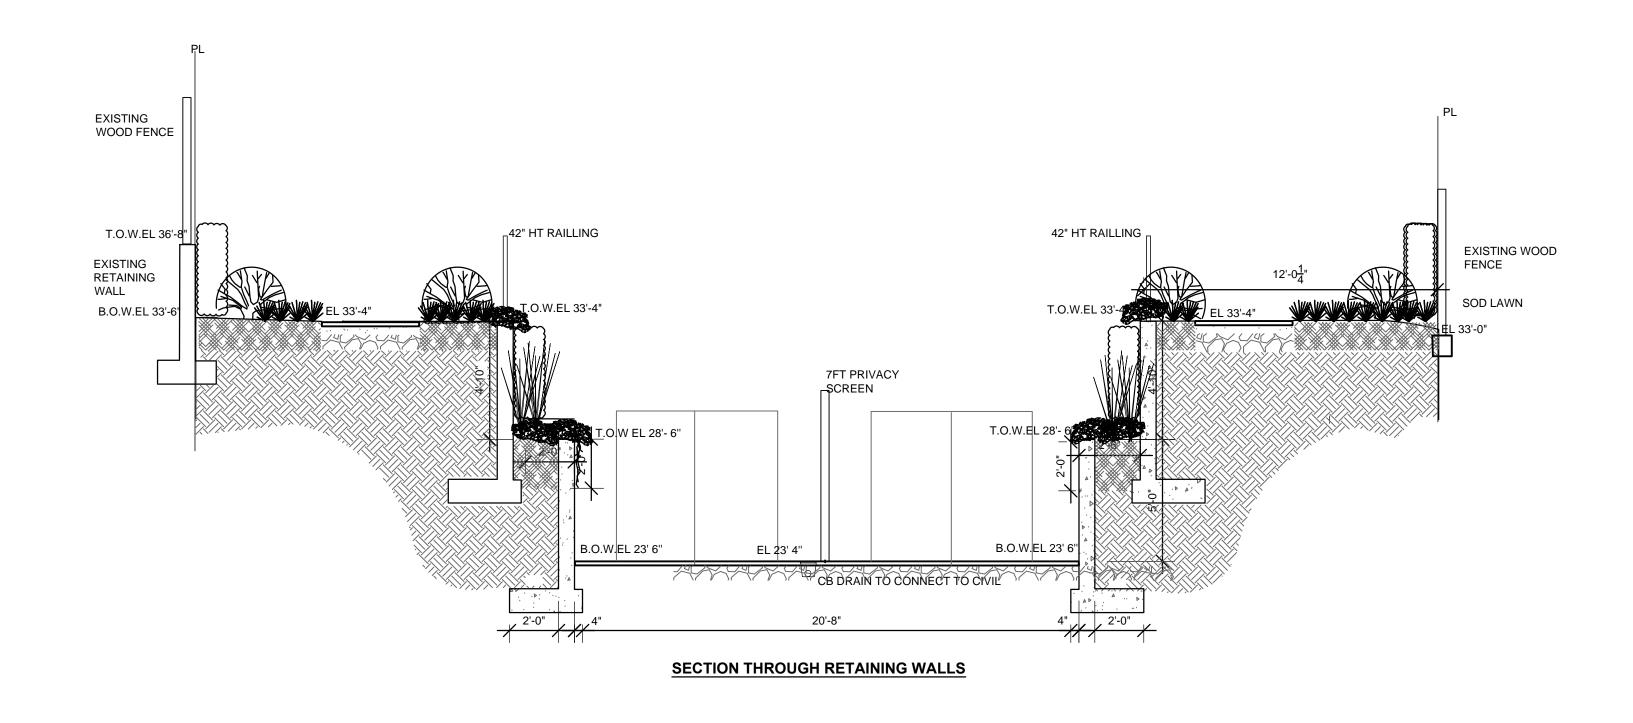

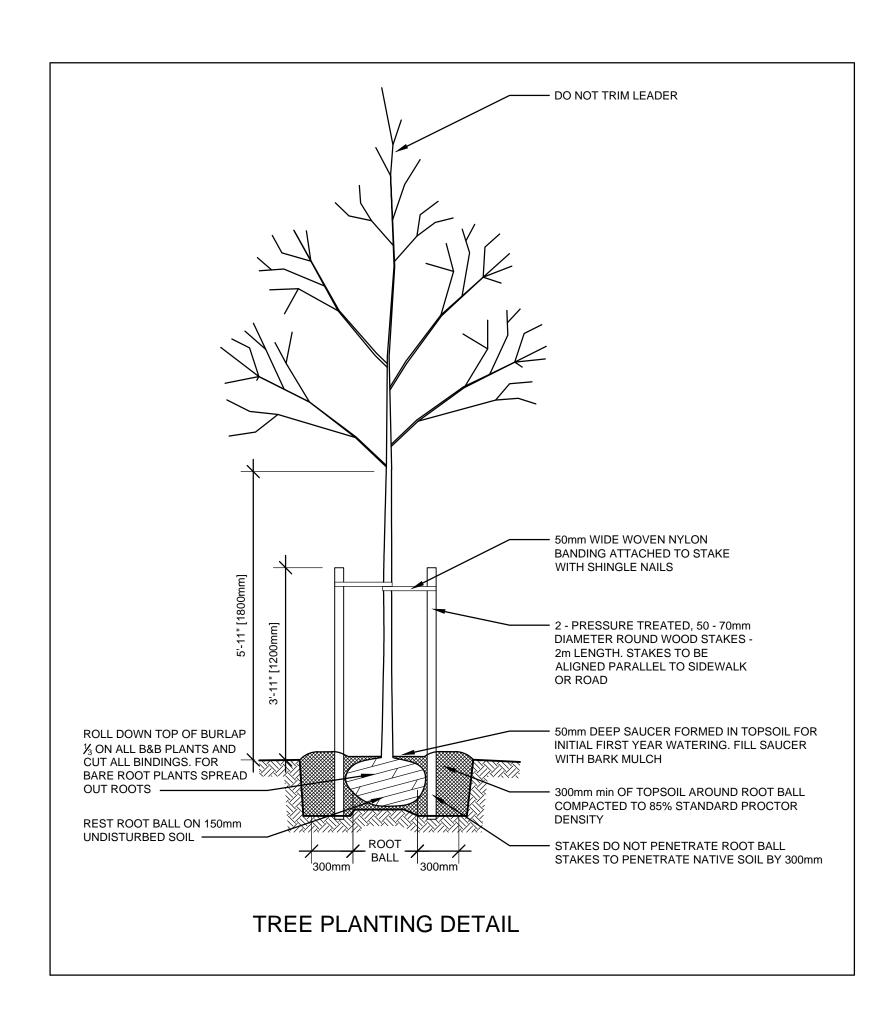

NOTES:

- I. ALL WORKMANSHIP AND MATERIALS SHALL BE IN CONFORMANCE WITH THE BCSLA
- LANDSCAPE STANDARDS & DISTRICT OF WEST VANCOUVER GUIDELINES
- 2. MIN GROWING DEPTHS OVER PREPARED SUB GRADE SHALL BE
 - LAWN AREAS 150MM
 GROUND COVER AREAS 230MM
 - SHRUB AREAS 450MM
 - TREE PITS 300MM ROOT BALL
- GROWING MEDIUM SHALL CONSIST OF 3 PARTS OF TOPSOIL AND ONE PART MUSHROOM MANURE
- TOPSOIL SHALL BE FRIABLE LOAM, FREE FROM ROOTS, WEEDS, STONES AND OVER 25MM
- OF FOREIGN OBJECTS
- 5. ALL PLANTING BEDS SHALL RECEIVE MIN 100MM (4 IN) BARK MULCH
- 6. PLANT SPECIES AND VARIETIES MAY NOT BE SUBSTITUTED WITHOUT THE APPROVAL OF
- THE LANDSCAPE DESIGNER AND MUST BE OF GOOD FORM AND VIGOR
- THE CONTRACTOR SHALL GUARANTEE ALL MATERIALS AND WORKMANSHIP FOR A PERIOD OF ONE FULL YEAR FROM THE DATE OF FINAL ACCEPTANCE, UNLESS OTHERWISE SPECIFIED.
- 8. ALL PLANT MATERIAL NOT SURVIVING, OR IN POOR CONDITION DURING THE GUARANTEE
- PERIOD SHALL BE REPLACED BY THE CONTRACTOR AT NO EXTRA COST TO THE OWNER.
- 9. IT IS THE OWNERS RESPONSIBILITY FOR THE SURVIVAL OF THE PLANT MATERIAL BY HAVING
- A MAINTENANCE CONTRACT BY A LANDSCAPE CONTRACTOR.

 10. THE CONTRACTOR SHALL CLEAR AWAY FROM THE SITE ALL RUBBISH AS IT ACCUMULATES

 AND SHALL AT THE COMPLETION OF WORK, LEAVE THE WORK AND SITE THEREOF IN A CLEAN
- AND PRESENTABLE CONDITION, FREE FROM ALL OBSTRUCTIONS.

 II. TREE PROTECTION BARRIER TO BE PROVIDED AROUND STREET TREES IN ACCORDANCE WITH

TREE PROTECTION BARRIER TO BE PROVIDED AROUND STREET TREES IN ACCORDANCE WITH THE DISTRICT OF WEST VANCOUVER GUIDELINES

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JUNE 30, 2016



PROJECT:
RESIDENTAIL DUPLEX

ENTAIL DUPLEX

ADDRESS:
6458 BRUCE STREET
WEST VANCOUVER, BC

NO. DESCRIPTION

REVISIONS

NO. DESCRIPTION

3 ROOF PATIO - GREEN SCREEN

PLANTING PLAN

CONCEPTUAL PLAN AND GRADING LAYOUT

	DESCRIPTION:		DWG NO.
DATE	PLANT LIST & NOTES	L3.0	
	PROJECT NO.		
23 JAN 2017	16007 A. GRIFFIOEN		
		_	

11 JULY 2016

30 JUNE 2016